

GENOA CHARTER TOWNSHIP APPLICATION Planned Unit Development (PUD)

A	PLICANT NAME: GRAND RIVER DORR, LLC (Mark Kassab)
Α	PLICANT EMAIL: MKASSAB@MSHAPIROREALESTATE.COM
A	31550 Northwestern Hwy, Suite 200 PLICANT ADDRESS & PHONE: Farmington Hill, MI 48334 .(248)865-0066
O	NER'S NAME: Grand River Dorr, LLC
O,	/NER ADDRESS & PHONE:same as above
T/	X CODE(S): 47-11-11-200-014, 47-11-14-100-002
Q	ALIFYING CONDITIONS (To be filled out by applicant)
1.	A PUD zoning classification may be initiated only by a petition.
2.	It is desired and requested that the foregoing property be rezoned to the following type of PUD designation:
	Residential Planned Unit Development (RPUD) Planned Industrial District (PID) Mixed Use Planned Unit Development (MUPUD) Redevelopment Planned Unit Development (RDPUD) Non-residential Planned Unit Development (NRPUD) Town Center Planned Unit Development (TCPUD)
3.	The planned unit development site shall be under the control of one owner or group of owners and shall be capable of being planned and developed as one integral unit.
EX	PLAIN The development will be developed, owned and operated by a single ownership entity
1 .	The site shall have a minimum area of twenty (20) acres of contiguous land, provided such minimum may be reduced by the Township Board as follows:
	A. The minimum area requirement may be reduced to five (5) acres for sites served by both public water and public sewer.
	B. The minimum lot area may be waived for sites zoned for commercial use (NSD, GCD or RCD) where the site is occupied by a nonconforming commercial, office or industrial building, all buildings on such site are proposed to be removed and a new use permitted within the underlying zoning district is to be established. The Township Popul stell and

that the flexibility in dimensional standards is necessary to allow for innovative design in redeveloping the site and an existing blighted situation will be eliminated. A parallel plan shall be provided showing how the site could be redeveloped without the use of the PUD to allow the

to be established. The Township Board shall only permit the PUD on the smaller site where it finds

minimum necessary to allow redevelopment of the site, while still meeting the spirit and intent of the ordinance.

- C. The PUD site plan shall provide one or more of the following benefits not possible under the standards of another zoning district, as determined by the Planning Commission:
 - preservation of significant natural or historic features
 - a complementary mixture of uses or a variety of housing types
 - common open space for passive or active recreational use
 - mitigation to offset impacts
 - redevelopment of a nonconforming site where creative design can address unique site constraints.
- D. The site shall be served by public sewer and water. The Township may approve a residential PUD that is not served by public sewer or water, provided all lots shall be at least one (1) acre in area and the requirements of the County Health Department shall be met.

Size of property is 51.9+/-	acres.
The proposed development is over 5 and provided common open space or community building and provided common open space or community building and provided or community building and community bu	ESTED PUD DESIGNATION COMPLIES WITH SIZE REQUIREMENTS. 1 acres. The development will preserve natural features portunities for the residents, including walking trails, a oi. The site is constrained by regulated wetlands and create straints. The site has access to public water supply and

STANDARDS FOR REZONING TO PLANNED UNIT DEVELOPMENT (RESPOND HERE OR WITHIN THE IMPACT STATEMENT)

 How would the PUD be consistent with the goals, policies and future land use map of the Genoa Township Master Plan, including any subarea or corridor studies. If conditions have changed since the Master Plan was adopted, the consistency with recent development trends in the area;

The future land use map for Genoa Township identifies mixed use town center. However, a change in need for retail services has been observed in the market. There is a lack of ability to attract new retail to compete with the existing retail services already located in the area. The proposed use is consistent with the high intensity use along the Grand River Corridor. This is consistent with surrounding land use and provides a transition to the residential areas to the south.

 The compatibility of all the potential uses in the PUD with surrounding uses and zoning in terms of land suitability, impacts on the environment, density, nature of use, traffic impacts, aesthetics, infrastructure and potential influence on property values;

The RPUD with an HDR underlying zoning is a transitional residential zoning that is typically found adjacent to high and medium intensity uses. This is consistent with this property and its surrounding uses. In this situation the property is surrounded by industrial, general business and office. There is residential to the north (higher density) and the south (lower density). The RPUD allows for additional open space, protection of natural features, and is supported by the existing infrastructure.

 The capacity of infrastructure and services sufficient to accommodate the uses permitted in the requested district without compromising the "health, safety and welfare" of the Township;

The proposed development will be compatible with past planning efforts and therefore the infrastructure is present to support it. The township services planned for this area will not be overtaxed by the development.

4. The apparent demand for the types of uses permitted in the PUD;
development area reaching various age demographics the
nature preservation and convenience to restaurants and shopping. This location is well located between
Brighton and Howell where downtown shopping and restaurants are available as well as the Genoa retail and restaurant area at Latson and Grand River.
retail and restaurant area at Latson and Grand River.
AFFIDAVIT
The undersigned says that they are the
Contact Information - Review Letters and Correspondence shall be forwarded to the following:
Name of PEA Group jcurry@peagroup.com
Business Affiliation E-mail
FEE EXCEEDANCE AGREEMENT As stated on the site plan review fee schedule, all site plans are allocated two (2) consultant reviews and one (1) to pay the actual incurred costs for the additional reviews. If applicable, additional review fee payment will be required concurrent with submittal to the Township Board. By signing below, applicant indicates agreement PROJECT NAME: Grand River Dorr
Planning Commission meeting. If additional reviews or meetings are necessary, the applicant will be required to pay the actual incurred costs for the additional reviews. If applicable, additional review fee payment will be and full understanding of this policy.
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GENOA CHARTER TOWNSHIP Application for Re-Zoning

OW	PLICANT NAME: Grand River Dorr, LLC ADDRESS: 315550 Northwestern Highway, ste 200 Farmington Hills, 41 NER NAME: Same as above ADDRESS:
	DDIMA DAY
EMA	AIL 1: Mkassab@mshapirorealestate.com EMAIL 2: the undersigned, do hereby regreets II.
amer herei	nd the Township Zoning Ordinance and change the zoning map of the township of Genoa as nafter requested, and in support of this application, the following facts are shown:
A. F	REQUIRED SUBMITTAL INFORMATION
2	A legal description and street address of the subject property, together with a map identifying the subject property in relation to surrounding properties; The name, signature and address of the owner of the subject property, a statement of the applicant's interest in the subject property if not the owner in fee simple title, and proof of the consent from the property owner;
3.	It is desired and requested that the foregoing property be rezoned from
	NSD/ MDR /TOWN CENTER to HDR/PUD
4.	A site plan illustrating existing conditions on the site and adjacent properties; such as woodlands, wetlands, soil conditions, steep slope, drainage patterns, views, existing buildings, sight distance
5. 6.	permitted in the requested zoning district meeting requirements for setbacks, wetland buffers
	A written environmental impact assessment, a map of existing site features as described in Article requested zoning district;
7.	A written description of how the requested rezoning meets Sec. 22.04 "Criteria for Amendment of the Official Zoning Map."
8.	The property in question shall be staked prior to the Planning Commission Public Hearing.
. DE	SCRIBE HOW YOUR REQUESTED RE-ZONING MEETS THE ZONING ORDINANCE ITERIA FOR AMENDING THE OFFICIAL ZONING MAP:
1.	How is the rezoning consistent with a
	How is the rezoning consistent with the goals, policies and future land use map of the Genoa Township Master Plan, including any subareas or corridor studies. If not consistent, describe how
	E ATTACHED

	SEE ATTACHED
3. S	Do you have any evidence that a reasonable return on investment cannot be received by developing the property with one (I) of the uses permitted under the current zoning? EE ATTACHED
3	How would all the potential uses allowed in the proposed zoning district be compatible with surrounding uses and zoning in terms of views, noise, air quality, the environment, density, traffic impacts, drainage and potential influence on property values? EE ATTATCHED
	Are infrastructure capacity (streets, sanitary sewer, water, and drainage) and services (police and fire protection, etc.) sufficient to accommodate the uses permitted in the requested district? EE ATTACHED
3	restricting to the requested district?

8. Describe any deed restrictions which could potentially affect the use of the property.
C. AFFIDAVIT
The undersigned says that they are the (owner, lessee, or other specified interest) involved in this petition and that the foregoing answers and statements herein contained and the information herewith submitted are in all respects true and correct to the best of his/her knowledge and belief.
BY: Mark Kassab, Grand River Dorr, LLC
ADDRESS: 315550 Northwestern Highway, ste 200 Farmington Hills, MI 48334 SIGNATURE
The following contact should also receive review letters and correspondence: Name: Jonathan Curry, P.E Email: jcurry@peagroup.com Business Affiliation: PEA Group
FEE EXCEEDANCE AGREEMENT
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PROJECT NAME: Grand River Dorr
PROJECT LOCATON & DESCRIPTION: 6080 W. Grand River Road
SIGNATURE: DATE: 6/2/22
PRINT NAME: Mark Kassab PHONE: 248-865-0066
COMPANY NAME & ADDRESS: 315550 Northwestern Hwy, Farmington Hills, MI 48334

B. 1.

Development conditions have changed since the approval of the Master Plan. Retail has seen a steep decline throughout the state. The ability of individuals to order online and have delivered to their home is one of the main reasons for this. It was further exasperated during covid pandemic and lock downs. Residents became used to online ordering.

High density residential is an acceptable use in the Town Center Overlay, however, this zoning is tied to being placed above retail. The existing zoning would allow for 28 units per acre when tied to retail. The proposed rezoning to HDR /RPUD reduces the density by allowing for 8 units per acre. This will reduce the burden on the township service and infrastructure.

2.

The southern side of the site consists of a regulated EGLE wetland and wooded areas. These natural features are desirable to protect. The proposed rezoning to HDR/RPUD allows for limiting disturbance to the natural features, while obtaining a financially viable project that provides the end user with desired environmental features.

3.

The evidence that a reasonable return on investment cannot be received by developing the property with one of the permitted uses under current zoning is evidenced by the lack of interest in the property. The property is in a desirable area; however, this area is located between developed areas that meet the residential services needs and retail for the area. Obtaining retail or residential service providers for this area is difficult because of the existing competition.

4.

As stated above, the proposed zoning was considered compatible with the master plan. However, it is desired to remove the retail component and town center overlay. The surrounding land uses along the Grand River corridor are higher intensity uses. The proposed use will be compatible with the existing users and could be considered a transitional zoning against the higher intensity industrial use to the west and the residential to the south.

5.

Infrastructure is available to service this site with the proposed rezoning. This area was master planned to provide the services necessary to develop this property successfully. The property is located adjacent to Grand River and Dorr Road. Sanitary sewer and public water main are available adjacent to the property as well.

6.

There is a demonstrated demand for the proposed uses allowed under HDR/RPUD. Genoa is in need of additional HDR/RPUD locations to assist residents wishing to downsize or even for younger residents to

enter into the area. The desire for younger and older residents is less maintenance with amenities. This site provides a club house with a pool, as well as the beauty of its existing nature areas left preserved.

7.

Currently, the town center does not appear to be desirable to developers. This is a prime location that should have developed. A rezoning at this time would provide additional developers options for this property should this development not continue for any reason.

8.

Currently there are no deed restrictions that would affect the property. However, if rezoned a deed restriction will be in place to protect the natural features and EGLE regulated wetland.



GENOA CHARTER TOWNSHIP Application for Site Plan Review

TO THE GENOA TOWNSHIP PLANNING COMMISSION AND TOWNSHIP BOARD:

APPLICANT NAME & ADDRESS: <u>Grand River Dorr, LLC</u> If applicant is not the owner, a letter of Authorization from Property Owner is needed.
OWNER'S NAME & ADDRESS: Grand River Dorr, LLC
SITE ADDRESS: 6080 W Grand River PARCEL #(s): 47-11-11-200-014,
APPLICANT PHONE: (248) 865-0066 OWNER PHONE: () 47-11-14-100-002
OWNER EMAIL: _mkassab@mshapriorealestate_com
LOCATION AND BRIEF DESCRIPTION OF SITE: 51.9 acres +/- at the South Fast Corner of
Grand River and Dorr Road
BRIEF STATEMENT OF PROPOSED USE:
The proposed use will be a RPUD - multifamily development consisting of 204 anathrough
homes in 18 buildings, with a community clubhouse and pool.
THE FOLLOWING BUILDINGS ARE PROPOSED:
and a community duphouse.
I HERERY CERTIES THAT ALL INCORNATION
I HEREBY CERTIFY THAT ALL INFORMATION AND DATA ATTACHED TO AND MADE PART OF THIS APPLICATIONAS TRUE AND ACCURATE TO THE BEST OF MY
KNOWLEDGE AND BELIEF.
BY: Jak Kassol
ADDRESS: <u>315550 Northwestern Hwy., Farmington Hills, MI 48334</u>
-

Contact Information - Review Let	ters and Correspondence shall be forwa	rded to the following:
1.) Mark Kassab	of Grand River Dorr, LLC Business Affiliation	at mkassab@mshapirorealestate.com E-mail Address

FEE EXCEEDANCE AGREEMENT

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SIGNATURE:

PRINT NAME: Mark Kassab

PHONE: 248-865-0066

ADDRESS: 315550 Northwestern Highway, ste 200 Farmington Hills 48334

GRAND RIVER DORR LLC

DBA

THE LEGACY APARTMENT HOMES

OWNER:

GRAND RIVER DORR LLC

PREPARED BY: MARK KASSAB

31550 Northwestern, ste 220

FARMINGTON HILLS, MI 48334

248-865-0066

THE LEGACY APARTMENT HOMES

CONCEPTUAL PUD SITE PLAN
APPLICATION & COMMUNITY IMPACT STATEMENT

The Legacy Apartment Homes | Conceptual PUD Submittal – Community Impact Statement



COMMUNITY IMPACT STATEMENT

- 1.0 General Project Information
 - 1.1 Project Overview
 - 1.2 Master Plan Analysis
 - 1.3 Surrounding Uses
- 2.0 Community and Facilities Services
 - 2.1 Police and Fire Demand
 - 2.2 Utilities
 - 2.3 Stormwater Management
- 3.0 Economics
 - 3.1 Tax Revenues Analysis
 - 3.2 Job Analysis
- 4.0 4.1 Natural resources Analysis
 - 4.2 Hazardous Materials
 - 4.3 Air Quality Impact
 - 4.4 Groundwater Impact
 - 4.5 Noise
- 5.0 Traffic
- 6.0 Development Statement

SECTION 1: GENERAL PROJECT INFORMATION

1.1 **Project Overview**

The Legacy Apartment Homes is a proposed residential community consisting of 204 attached apartments with an associated clubhouse and pool. The project shall include open space and other elements as set forth in this Agreement and the PD plan. The project will include approximately 29 acres of total open space. This site is currently vacant and is zoned Neighborhood Services District (NSD) and Medium Density Residential (MDR) with Town Overlay and currently petitioning to be rezoned to High-Density Residential (HDR), and Residential Planned Unit Development (RPUD).

The proposed land use consists of multi-family apartment homes. The project will have 3.92 units per acre based on 52 +/- gross acreage and 6.23 units per acre based on 32.77 net acreage. The proposed development will be compatible with past planning efforts and therefore the infrastructure is present to support it. The township services planned for this area will not be overtaxed by the development.

Unit counts and densities for the proposed The Legacy Apartment Homes are as follows:

204 Multi-Family Dwelling Units (51 gross Acres/33 Net Acres):

3.92 DU/Gross Acre 6.23 DU/Net Acre

1.2 <u>Master Plan Analysis</u>

- ➤ Value communities and neighborhoods The Legacy Apartment Homes will be an exclusive neighborhood community targeting demographics of multiple ages. The development will focus on quality building materials and attention to architecture details. This location is well located between Brighton and Howell where downtown shopping and restaurants are available as well as the Genoa retail and restaurant area at Latson and Grand River.
- Walkable neighborhoods In addition to sidewalk proposed on both sides of the planned internal roadways, the development will also have a system of pathways within the extensive open space areas.

➤ Variety of recreational facilities – The Legacy Apartment Homes proposes a successful development area reaching various age demographics that seek amenities, less maintenance, nature preservation and convenience to restaurants and shopping. sidewalks and interconnectivity within the community, dog park, gazebo, EV Charging Stations throughout, benches, clubhouse, Amazon Hub station, pool and fitness center consisting of a Yoga room, business center, dog wash to accommodate residents of all ages, interests, and physical abilities.

Refer to the Conceptual PUD for additional information of the neighborhood layout and representative architectural details.

1.3 Existing Surrounding Uses

As shown within the attached zoning map, the existing surrounding uses for the subject site are uses of varying densities. These existing uses are as follows:

North: GCD- General Commercial District

• East: OSD

West: Industrial

South: Rural Residential

SECTION 2: COMMUNITY AND FACILITY SERVICES

2.1 Police and Fire Demand

The Livingston County Sheriff in addition to the Michigan State Police will be providing Public Safety services required to accommodate the proposed use.

The Brighton Area Fire Department, as part of an existing Governmental agreement will provide fire protection services. There will be numerous fire hydrants located on the subject property. Fire Department Connections (FDC's) will be located on each building in addition to the buildings having an internal fire suppression system. Station 34 on Dorr Road is located approximately¼ mile away from the subject property.

The property is accessed from Grand River and Dorr Road. Both entrances are designed to accommodate emergency vehicle access.

A fiscal impact statement is prepared and attached to the CIS to determine the annual tax revenue. The additional net annual tax revenue at full buildout will be approximately \$836,662. The additional tax revenues are in addition to the one-time utility connection charges in the amount of \$3,080,400.

2.2 Utilities

Utility services will be provided by existing public water and sewer systems in the area. The development proposes a total of 204 apartment unit connections to the existing public utilities. We estimate an average daily usage of 36,500 gallons per year per person with an annual usage of approximately 19,000,000 gallons per year.

All utility lines, structures, and trenches shall be constructed in accordance with the standards and requirements of Genoa Township, the Livingston County and MDOT. All hydrants will be a minimum of 4.5' from back of curb.

Water main connections to the existing mains will be completed to provide for a looped system in accordance with the Township standards and placed within public easements. The proposed site water mains will be 8" in diameter and placed in public easements, and will connect to the existing 12" main on Dorr Road 16" main on Grand River Rd.

Site Storm sewer will be privately owned and designed to convey runoff to appropriately sized stormwater management facilities.

2.3 Stormwater Management

Stormwater management for quality treatment and flood storage will be provided in proposed detention basin optimally located at the southeast corner of Grand River and Dorr Road. These basin will be designated and approved in accordance with Livingston County Drain Commission standards to accommodate the 100-year frequency storm runoff from the proposed development.

						NS POND	1:
				SSTON COUNTY		SSIONER)	
	urbed Area	, A	=	13.40	acres		
Parking ar			=	3.90	acres	C1 = 0.90	
	Pool and	Deck	=	1.18	acres	C2 = 0.90	
Buildings				2.78	acres	C3 = 0.90	
Grass Landscape Area				5.37	acres	C4 = 0.25	
Wet Pond	Surface			0.17	acrea	C5 = 1.0	
Compound	d Run-off C	oefficient, C	_	0.64			
	onstant, K		-	8.58			
	Outflow Ra		-	0.2 cfs/acre			
		, 40	=	2.68	CFS		
1	2	3	Н	4	5	6	7
1	- 2	3	-	- 1	-	-	_
Duration (min) Duration 100-year intensity (In/Hr)		Col#2*Col#3 (inches)		Inflow Volume (CF) = Col#4*K	Allowable Outflow Volume (CF) = Col#2*Qo	Storage Volume (CF) Col#5-Col#	
5	300	9.17		2,750	23,584	804	22,780
10	600	7.86	\vdash	4,714	40,430	1,608	38,822
15	900	6.88	\vdash	6,188	53,064	2,412	50,652
20	1200	6.11	\vdash	7.333	62,891	3,216	59,675
30	1800	5.00	-	9,000		3,216 4,824	
			-		77,184		72,360
60	3600	3.24	-	11,647	99,885	9,648	90,237
70	4200	2.89	_	12,158	104,266	11,256	93,010
80	4900	2.62	_	12,571	107,813	12,864	94,949
90	5400	2.39	_	12,913	110,742	14,472	96,270
120	7200	1.90		13,655	117,107	19,296	97,811
	140 8400 1.67				120,064		97,552
140	8400	1.67		14,000	120,064	22,512	97,552
145	8700	1.62	Sto	14,074	120,695	23,316	97,379
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145 Detention Sediment Volume P	8700 Volume Re Forebay C	1.62 equired for 100-yr apacity = 5% of	100-	14,074 rm Event =	120,695 97,811	23,316 CF	
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Detention Sediment Volume P Elevation 978 977 976 975 974 973 972 971 Storage V	8700 Volume Rix Forebay C rovided in I Surface Area (SF) 30,451 29,594 26,537 23,545 20,636 17,097 13,857 olume Provided in II	1.62 equired for 100-yr spacity = 5% of Detention Basin Volume (CF) 28,088 25,041 22,101 18,877 15,477 6,929	To	14,074 em Event = yr volume = otal Volume (CF) 116,489 88,424 63,383 41,282 22,406 6,929 0 116,489 otal Volume (CF)	120,695 97,811 4,891	23,316 CF	
Detention Sediment Volume P Elevation 978 977 976 975 974 973 972 971 Storage V	8700 Volume Ric Forebay C rovided in [Surface Area (SF) 30,451 29,594 26,537 23,545 20,636 17,097 13,857 olume Provided in 8 Surface	1.62 equired for 100-yr apacity = 5% of Detention Basin Volume (CF) 28,088 25,041 22,101 18,677 15,477 6,929 added = Sediment Foreba	To	14,074 em Event = yr volume = otal Volume (CF) 116,489 88,424 63,383 41,282 22,406 6,929 0 116,489	120,695 97,811 4,891	23,316 CF	
Detention Sediment Volume P Elevation 978 977 976 975 975 972 971 Storage V Volume P Elevation	8700 Volume Ric Forebay C rovided in [Surface Area (SF) 30,451 29,594 26,537 23,545 20,636 17,097 13,857 olume Provided in 8 Surface	1.62 equired for 100-yr apacity = 5% of Detention Basin Volume (CF) 28,088 25,041 22,101 18,677 15,477 6,929 added = Sediment Foreba	To	14,074 em Event = yr volume = otal Volume (CF) 116,489 88,424 63,383 41,282 22,406 6,929 0 116,489 otal Volume (CF)	120,695 97,811 4,891	23,316 CF	
145 Detention Sediment Volume P Elevation 978 977 976 975 974 973 972 971 Storage V Volume P Elevation	8700 Volume Rice Forebay Convided in I Surface Area (SF) 30,451 29,594 20,597 23,545 20,637 13,857 olume Provided in Surface Area (SF)	1.62 soulined for 100-y- supeoily = 5% of Detention Basin Volume (CF) 28,068 25,041 22,101 18,877 19,477 6,929 added = Sediment Foreba Volume (CF)	To	14,074 em Event = yr volume = otal Volume (CF) 116,489 88,424 63,383 41,282 22,406 6,929 0 116,489 otal Volume (CF)	120,695 97,811 4,891	23,316 CF	
145 Detention Sediment Volume P Elevation 978 977 976 975 974 973 972 971 Storage V Volume P Elevation 975 974	8700 Volume Riceptor Control of the	1.62 cquired for 100-yr appeality = 5% of Detention Bassin Volume (CF) 28,068 25,041 22,101 18,677 15,477 6,929 deded = Sediment Foreba Volume (CF) 4,455	To	14,074 em Event = yr volume = otal Volume (CF) 116,489 88,424 63,383 41,282 22,406 6,929 0 116,489 otal Volume (CF)	120,695 97,811 4,891	23,316 CF	
Detention Sediment Volume P Elevation 978 977 976 975 972 971 Storage V Volume P Elevation 975 975 977 979	8700 Volume Ric Forebay C rovided in I Surface Area (SF) 39,451 29,594 20,636 17,097 13,857 olume Provided in S Surface Area (SF) 5,006 3,910	1.62 cquired for 100-yr appeality = 5% of Detention Bassin Volume (CF) 28,068 25,041 22,101 18,677 15,477 6,929 deded = Sediment Foreba Volume (CF) 4,455	To	14,074 em Event = yr volume = otal Volume (CF) 116,489 88,424 63,383 41,282 22,406 6,929 0 116,489 otal Volume (CF)	120,695 97,811 4,891	23,316 CF	
Detention Sediment Volume P Elevation 978 977 976 975 974 973 972 971 Storage V Volume P Elevation 975 974 973 972 971	8700 Volume Rx Forebay C Surface Area (SF) 39,451 29,594 26,537 23,545 20,636 17,097 13,857 olume Provided in 8 Surface Area (SF) 5,006 3,910 2,927	1.62 soulined for 100-y- sapeoily = 5% of betention Basin Volume (CF) 28,068 25,041 22,101 18,877 19,477 6,929 addd = sediment Foreba Volume (CF) 4,455 3,419	To	14,074 In Event = yr volume = otal Volume (CF) 116,489 88,424 63,383 41,282 22,406 6,929 0 116,489 otal Volume (CF) 7,877	120,695 97,811 4,891	23,316 CF	
Detention Sediment Volume P Elevation 978 977 976 975 974 973 972 971 Storage V Volume P Elevation 975 974 973 972	8700 Volume Rx Forebay C Surface Area (SF) 39,451 29,594 26,537 23,545 20,636 17,097 13,857 olume Provided in 8 Surface Area (SF) 5,006 3,910 2,927	1.62 cquired for 100-yr appeality = 5% of Detention Bassin Volume (CF) 28,068 25,041 22,101 18,677 15,477 6,929 deded = Sediment Foreba Volume (CF) 4,455	To	14,074 em Event = yr volume = otal Volume (CF) 116,489 88,424 63,383 41,282 22,406 6,929 0 116,489 otal Volume (CF)	120,695 97,811 4,891	23,316 CF	

				SSTON COUNTY			
Total Disturbed Area, A			=	10.47	acres		
Parking and Road Sidewalks			=	2.85	acres	C1 = 0.90	
			=	0.53	acres	C2 = 0.90	
Buildings Grass/Landscape Area				2.20	acres	C3 = 0.90	
Grass/Lar	ndscape An	68	=	4.89	acres	C4 = 0.25	
Compoun	d Run off C	oefficient, C	-	0.60			
Design Constant, K = A*C Allowable Outflow Rate, Qo			=	6.24			
			=	0.2 cfs/acre			
			=	2.09	CFS		
1	2	3		4	5	6	7
Dumbier	Duration	100 1000			Inflow Volume	Allowable Outflow	Storage
Duration Duration 100-year (min) (sec) intensity (In/Hr)		Co	#2*Col#3 (inches)	(CF) = Co#4*K	Volume (CF) = Col#2*Qo	Volume (CF) Col#5-Col#6	
5	300	9.17		2,750	17,172	628	16,544
10	600	7.86		4,714	29,438	1,256	28,182
15	900	6.88		6,188	38,638	1,885	36,753
20	1200	6.11		7,333	45,793	2,513	43,280
30	1800	5.00		9,000	56,201	3,769	52,431
60	3600	3.24		11,647	72,730	7,538	65,192
70	4200	2.89		12,158	75,920	8,795	67,125
80	4800	2.62		12,571	78,502	10,051	68,451
90	5400	2.39		12,913	80,638	11,308	69,328
120	7200	1.90		13,855	85,270	15,077	70,193
140	8400	1.67		14,000	87,423	17,590	69,833
145	8700	1.62		14,074	87,882	18,218	69,664
		equired for 100-yr		rm Event =	70.193	CF	
		apacity = 5% of	100	yr volume =	3,510	CF	
Volume P	rovided in [Detention Basin	100	yr volume =		CF	
	rovided in [Octention Basin		yr volume = otal Volume (CF)		CF	
Volume P	rowided in E Surface	Octention Basin				CF	
Volume P Elevation 980.5	rowlded in E Surface Area (SF)	Volume (CF)		otal Volume (CF)		CF	
Volume P Elevation 980.5 979.5	rowided in E Surface Area (SF) 34,968	Volume (CF)				CF	
Volume P Elevation 980.5	Surface Area (SF) 34,968 30,174	Volume (CF) 32,571 27,959		otal Volume (CF) 80,267		CF	
Volume P Elevation 980.5 979.5 978.5	rowided in E Surface Area (SF) 34,968	Volume (CF)		otal Volume (CF) 80,267 47,696		CF	
980.5 979.5 978.5 976.5	34,968 30,174 25,743 13,731	Volume (CF) 32,571 27,959 19,737		80,267 47,696 19,737 0	3,510	CF	
980.5 979.5 978.5 976.5	34,968 30,174 25,743	Volume (CF) 32,571 27,959 19,737		otal Volume (CF) 80,267 47,666 19,737		CF .	
980.5 979.5 977.5 978.5 978.5	34,968 30,174 25,743 13,731	2ctention Basin Volume (CF) 32,571 27,959 19,737	Te	80,267 47,696 19,737 0	3,510	CF	
980.5 979.5 978.5 978.5 978.5 978.5	Surface Area (SF) 34,968 30,174 25,743 13,731 folume Provinced in S	Volume (CF) 32,571 27,959 19,737	Te	80,267 47,696 19,737 0	3,510	CF	
980.5 979.5 978.5 978.5 978.5 978.5	Surface Area (SF) 34,968 30,174 25,743 13,731 folume Prox	Octention Basin Volume (CF) 32,571 27,950 19,737 added =	Te	80,287 47,696 19,737 0 80,267	3,510	CF	
980.5 979.5 978.5 978.5 978.5 978.5 Storage V	Surface Area (SF) 34,968 30,174 25,743 13,731 folume Proviousle In S Surface Area (SF)	Octention Basin Volume (CF) 32.571 27,959 19,737 Mided = Sediment Foreba Volume (CF)	Te	80,287 47,696 19,737 0 80,267	3,510	CF	
980.5 979.5 978.5 978.5 978.5 978.5 978.5 Storage V Volume P Elevation 979.5	34,968 30,174 25,743 13,731 Colume Provided in S Surface Area (SF) 4,641	22.571 27.959 19.737 Addd = Sediment Foreba Volume (CF)	Te	80,287 47,696 19,737 0 80,267	3,510	CF	

SECTION 3: ECONOMICS

3.1 Tax Revenue Analysis

A fiscal impact analysis was prepared to determine the anticipated annual tax revenue to be generated as a result of the development. Based on this analysis, we anticipate Legacy Apartment Homes will have a taxable value of approximately \$22,950,000 and will generate an annual revenue gain of approximately \$911,139. Currently the property is generating \$24,659 in annual taxes.

3.2 Jobs Created

Legacy Apartment Homes will be a residential development. Legacy Apartment Homes will create 100 +/- construction jobs during the installation of the infrastructure and the building of the apartment buildings on the site. In addition,

The Legacy Apartments will employ 5-6 permanent leasing and maintenance staff.

Refer to **Exhibit A** for the Fiscal Impact Analysis Calculations

SECTION 4: ENVIRONMENT

4.1 Natural Resources Analysis

The proposed development is approximately 52 acres. The development will preserve natural features and provided common open space opportunities for the residents, including walking trails, a community building and swimming pool. The site is constrained by regulated wetlands to the South and Southeast portion of the property. The area of proposed development is primarily vacant farmed land with minimal to no tree removal required.

Storm water runoff for the site will be detained and treated in accordance with applicable Township, County and State requirements prior to discharge from the site. No significant impact or pollution to offsite water bodies is anticipated with the development.

The proposed development will seek to preserve existing wooded areas around the perimeter of the development where grading would allow, to serve as a buffer between the development and neighboring properties. New trees will be planted in the proposed development in accordance with an approved Landscaping Plan.

4.2 Hazardous Materials

No hazardous materials are planned to be manufactured, used, or stored on site.

4.3 Air Quality Impact

Legacy Apartment Homes is a residential development that does not plan to have any significant impact to the air quality of the area. No quantifiable type or quantities of pollutants are expected to be released in the air. During construction, special measures will be included within the Soil Erosion and Sedimentation (SESC) Plan to mitigate any potential dust creation during dryer site conditions, including the use of water trucks.

4.4 **Groundwater Impact**

Legacy Apartment Homes is a residential development that will utilize connections to the existing public utilities in the area. The development fits within

the master planned unit density for the area and does not plan to have any significant impact to the groundwater levels within the area.

4.5 Noise

Legacy Apartment Homes is a residential development that does not plan to have any significant impact to the increased noise in the area. During construction, the development intends to minimize noise as reasonable and follow the Township's ordinance regarding hours of allowed construction operation.

SECTION 5: TRAFFIC

Legacy Apartment Homes is a residential project consisting of a multi-family dwelling units that are proposed to have access off Grand River Road in addition to Dorr Road. The main access to the community will be from Grand River Road which is a State Road. There is a secondary access off Door Road.

A Traffic Impact Study (TIS) has been prepared by Rowe Engineering in accordance with the Township Ordinance. The report was completed in accordance with the requirements specified by the Michigan Department of Transportation (MDOT), the Road Commission for Oakland County (RCOC), and Genoa Township.

A copy of the TIS attached as **Exhibit B.**

DEVELOPER'S STATEMENT

After a five decades of residential building in Michigan, MJC Companies® is proud to be one of the state's largest privately-owned and operated builders, as well as one of the top 100 builders in the nation. Since 1972, the company has garnered a reputation of value and innovation with single-family homes and condominiums that offer a carefree lifestyle in desirable neighborhoods.

And that reputation still holds true today. With deep roots in an array of communities in Livingston, Macomb, Oakland and Wayne counties, MJC Companies® is excited to be a part of Michigan's rich history and is confident in the future of the state and dedicated to the families who live here.

Specializing in new construction, MJC Apartment homes and condominiums offer a wide choice of locations, flexible floor plans, and an abundance of the most desired amenities within pleasant communities including some with pools, walking trails and ponds.

MJC Companies® looks forward to enduring its longstanding presence in Southeast Michigan as it continues to develop communities of choice for generations to come.

Charities, Sponsorships & Clubs

- Alzheimer's Association
- Building Industry Association Charitable and Education Foundation
- Capuchin Soup Kitchen
- Cardinal Mooney Catholic High School
- Children's Charities at Adios
- Club Calabria
- Club Terrasini
- Club Di Santa Fara
- De La Salle Collegiate High School
- Fraternal Order of Police
- Interfaith Volunteer Caregivers
- Italain American Culture Society
- Karmanos Cancer Institute
- Mackinac Island Historical Preservation
- March of Dimes
- Men of the Sacred Heart
- Michigan Historical Society
- Mat Gaberty Heart Fund
- Macomb Foundation
- Mt. Clemens General –Board Member
- Mt. Clemens Regional Oncology
- Multiple Sclerosis Foundation
- MPURE Department of Urology at William Beaumont Hospital
- Muscular Dystrophy Association
- National Italian American Foundation
- Northville Park & Recreation
- Nothdurft Pediatric Endowment
- Special Olympics
- St. John Health Foundation
- St. John Hospital Guild
- St. Lawrence Athletics
- St. Louis Center— (helping to raise, \$800,000 dollars in the last 10 years)
- Utica Community Schools
- USC Shoah Foundation

EXHIBIT A

FISCAL IMPACT STATEMENT

The Legacy Apartments Homes - 204-Unit Community Fiscal Impact

Property Development Property Tax Revenue

	Housing Type	Market Value Per Unit	State Equalized Value Per Unit	Taxable Valu Per unit	e Total Units	Estimated Market Value	Est	imated Taxable Value
	Apartment Homes	\$ 225,000	\$ 225,000	\$ 112,		\$ 45,900,000		22,950,000 22,950,00 0
Marke Value Valu						=		
MUMBER TAX REVENUE GENERATION					ble Tax Generated			
County Tax	SUMMER TAX REVENUE GENERATION					_		
18,000 19,000 19,000 5 22,950,000 5 413,100 19,000 1	itate Ed Tax							
	•							
Windingston	•							
18 Fire Auth								
WINTERT AR REVENUE GENERATION CHAPTAPIS CAUCHY APPRIAIRES								
Country Ambulance 0.2863 5 22,950,000 5 6,571 CMAP 2			0.8733	\$ 22,550,0	20,042			
CAM-Parks 0.2089 \$ 2,2550,000 \$ 4,794			0.2863	\$ 22.950.0	000 \$ 6.571			
National								
10 School Debt	/eterans Relief		0.1127					
1.0382 \$ 2,980,000 \$ 23,827 \$ 2,985,000 \$ 23,827 \$ 2,985,000 \$ 3,44.25 \$ 2,985,000 \$ 3,44.25 \$ 2,985,000 \$ 3,44.25 \$ 2,985,000 \$ 3,44.25 \$ 2,985,000 \$ 3,44.25 \$ 2,985,000 \$ 3,44.25 \$ 2,985,000 \$ 3,44.25 \$ 2,985,000 \$ 3,44.25 \$ 2,985,000 \$ 3,44.25 \$ 2,985,000 \$ 3,44.25 \$ 2,985,000 \$ 3,24,059 \$ 2,985,798 \$ 2,	Senoa Alloc		0.7855	\$ 22,950,0	000 \$ 18,027			
Annual Water/Sewer Annual Water Usage Fees **Township Expenditures Per Budget** **Total Extimated Fees*** **Total Feed **** **Total Extimated Fees*** **Tota	10 School Debt		2.7500	\$ 22,950,0				
Total Estimated Annual Revenue from Property Taxes	· · · · · · · · · · · · · · · · · · ·							
Section Property Tax Revenue Generation Fotal Net annual Revenue from Property Taxes Section Sec			1.5000	\$ 22,950,0				
Sample S	Total Estimated Annual Revenue from Property Taxes				\$ 935,798			
Settimated Revenue from Property Taxes Estimated Residents and Use Units Units Unit Factor Per Us Census Population Water Capital Connection Fee Water and Sewer Capital Connection Fee Water Capital Sewer Capital Fee Charges Units Soliding Type Units Soliding Type Units Units Soliding Type Units Units Soliding Type Units Units Units Units actor Per Capital Fee Total Capital Fee Charges Total Units Usage (Fees per. DPS) Annual Usage (Gal); (Fees per. DPS) Usage Fees Usage Gal Total Estimated Population (Gal); (Fees per. DPS) Annual Water Usage Fees Total Capital Gal Fees Total Utility-Related Fees Formunity Expenditures Per Budget Formunity Expenditures Per Budget Formunity Expenditures Per Resident ## Residents ## Residents Expenditure per Resident Total Formula Total Fees Total Units actor Per Soliding Type Units actor Per Soliding Type Units actor Per Type Total Capital Fee Total Units Formunity Expenditures Fees Ident ## Residents Expenditure per Resident Total Fees Total Capital Fees T	oss Current Branchy Tay Poyenus Constation				¢ 24.6E0	_		
Annual Water/Sewer Usage Fees Annual Water Sewer September						_		
Annual Water/Sewer Usage Fees Annual Water Sewer September	Estimated Residents							
Residential 204 205 SENOR Popis Residential 204 205 SENOR Sever Capital Fee Capital Fee Capital Capita			Units			Unit Factor Per	,	Projected
Utility Revenue Water Capital Sewer Capital Fee Total Capital Total Units Water and Sewer Capital Connection Fee Fee Total Capital Total Units Water and Sewer Capital Connection Fee Total Capital Total Units S 7,900.00 \$ 7,200.00 \$ 15,100 \$ 204 \$ \$ 3,000 \$ \$ 3,000 \$ \$ 3,000 \$ \$ 3,000 \$ \$ \$ 3,000 \$ \$ \$ 3,000 \$ \$ \$ 3,000 \$ \$ \$ \$ \$ \$ \$ \$ \$ \$ \$ \$ \$ \$ \$ \$ \$ \$						Us Census		Population
Water and Sewer Capital Connection Fee	Residential		204			2.55		520
Fee Charges Total Units Total Units S 7,900.00 S 7,200.00 S 15,100 204 S 3,000 S 3,000 S 15,100 S 3,000 S 3,00	Utility Revenue							
Building Type Units \$ 7,900.00 \$ 7,200.00 \$ 15,100 204 \$ \$ 3,1 \$ \$ \$ \$ \$ \$ \$ \$ \$ \$ \$ \$ \$ \$ \$ \$ \$ \$ \$	Water and Sewer Capital Connection Fee		-	Sewer Capital		Total Units	Т	Total Estimated Fee
Julits \$ 7,900.00 \$ 7,200.00 \$ 15,100 204 \$ 3,30	Building Type		166		Charges	Total Ollits		
Annual Usage Usage (Gall); Annual Water/Sewer Population gal/yr/person Gal. Same 36,500 fee/1000 Total Estimated Fees Solution Same 36,500 fee/1000 Fees Same 36,500 fees Same 36,			\$ 7,900.00	\$ 7,200	0.00 \$ 15,100	204		\$ 3,080,400
Annual Usage (Gal): Estimated Assume 36,500 fee/1000 Total Estimated Population gal/yr/person Gal. Apartments 520 18,987,300 \$11.28 \$ Annual Water \$ Some sees \$ Foundal Utility-Related Fees \$ Foundal Utility-Related Fees \$ Foundal Expenditures Per Budget Foundal Expenditures Per Resident \$ # Residents Expenditure per Resident Total Fees Batting and South State (Fees Per Budget) Foundal Expenditures Per Resident Total # Residents Expenditure per Resident Total Foundal Annual Expenditures for Legacy Apartment 520 \$ 309.89 \$ 161							\$	-
Annual Usage Usage (Gal): Estimated Assume 36,500 fee/1000 Total Estimated Population gal/yr/person Gal. Apartments 520 18,987,300 \$11.28 \$ Annual Water \$ Fotal Utility-Related Fees \$ Fotal Expenditures Per Budget Fotal Expenditures - 2022 Budget (per Genoa.org) \$ Fownship Expenditures Per Resident \$ # Residents Expenditure per Resident Total Fees Population (gal): Annual Water \$ S Fotal Utility-Related Fees \$ Fotal Expenditures Per Budget \$ Fotal Expenditures Per Resident \$ Fotal Expenditure Per Resident \$ Fotal Expenditur	Total Estimated Connection Fee			/F 0.0	a)	204		\$ 3,080,400
Annual Water/Sewer Usage Fees Apartments Apartments Apartments Fotal Utility-Related Fees Fotal Utility-Related Fees Fotal Expenditures Per Budget Fotal Expenditures - 2022 Budget (per Genoa.org) Fownship Expenditures Per Resident Fotal Annual Expenditures for Legacy Apartment # Residents Estimated Assume 36,500 fee/1000 fee/1000 gal/yr/person Gal. Fees Fotal 18,987,300 \$11.28 \$ Annual Water Usage Fees \$ Fotal Utility-Related Fees \$ \$ Fotal Utility-Related Fees \$ Fotal U				(Fees per. DP	S)			
Annual Water/Sewer Usage Fees Apartments Spartments				Annual Usag	a Usaga			
Annual Water/Sewer Population gal/yr/person Gal. Total Estimated Population gal/yr/person Gal. Fees Apartments 520 18,987,300 \$11.28 \$ \$ \$ \$ \$ \$ \$ \$ \$ \$ \$ \$ \$ \$ \$ \$ \$ \$ \$								
Usage Fees Apartments 520 18,987,300 \$11.28 \$ Annual Water Usage Fees Total Utility-Related Fees \$ Township Expenditures Per Budget Total Expenditures - 2022 Budget (per Genoa.org) Township Population (per 2020 SEMCOG) Township Expenditures Per Resident # Residents # Residents Expenditure per Resident Total Total Annual Expenditures for Legacy Apartment 520 \$ 309.89 \$ 161			Estimated	Assume 36,50	00 fee/1000			Total Estimated
Apartments 520 18,987,300 \$11.28 \$ Annual Water Usage Fees Fotal Utility-Related Fees \$ Township Expenditures Per Budget Total Expenditures - 2022 Budget (per Genoa.org) Fownship Population (per 2020 SEMCOG) Township Expenditures Per Resident \$ # Residents Expenditure per Resident Total Total Annual Expenditures for Legacy Apartment 520 \$ 309.89 \$ 161			Population	gal/yr/perso	n Gal.			Fees
Annual Water Usage Fees Total Utility-Related Fees \$ Township Expenditures Per Budget Total Expenditures - 2022 Budget (per Genoa.org) \$ 6,4 Township Population (per 2020 SEMCOG) Township Expenditures Per Resident \$ # Residents Expenditure per Resident Total Total Annual Expenditures for Legacy Apartment 520 \$ 309.89 \$ 161			520	18.987.300	\$11.28		\$	214,177
Township Expenditures Per Budget Total Expenditures - 2022 Budget (per Genoa.org) \$ 6,4 Township Population (per 2020 SEMCOG) Township Expenditures Per Resident \$ # Residents Expenditure per Resident Total Total Annual Expenditures for Legacy Apartment 520 \$ 309.89 \$ 161								214,17
Township Expenditures Per Budget Fotal Expenditures - 2022 Budget (per Genoa.org) \$ 6,4 Fownship Population (per 2020 SEMCOG) Fownship Expenditures Per Resident \$ # Residents Expenditure per Resident Total Fotal Annual Expenditures for Legacy Apartment 520 \$ 309.89 \$ 161				Usage Fees				
Township Expenditures Per Budget Total Expenditures - 2022 Budget (per Genoa.org) \$ 6,4 Township Population (per 2020 SEMCOG) Township Expenditures Per Resident \$ # Residents Expenditure per Resident Total Total Annual Expenditures for Legacy Apartment 520 \$ 309.89 \$ 161	Fotal Utility-Related Fees						\$	214,177
Fortal Expenditures - 2022 Budget (per Genoa.org) \$ 6,6 Fownship Population (per 2020 SEMCOG) Fownship Expenditures Per Resident \$ Total Fortal Annual Expenditures for Legacy Apartment 520 \$ 309.89 \$ 161	Fownship Expanditures Box Budget							
Fownship Population (per 2020 SEMCOG) Fownship Expenditures Per Resident \$ # Residents Expenditure per Resident Total Fotal Annual Expenditures for Legacy Apartment 520 \$ 309.89 \$ 161	Township Expenditures Fer Budget							
Fownship Expenditures Per Resident \$ # Residents Expenditure per Resident Total Fotal Annual Expenditures for Legacy Apartment 520 \$ 309.89 \$ 161	Fotal Expenditures - 2022 Budget (per Genoa.org)						\$	6,412,166
# Residents Expenditure per Resident Total Fotal Annual Expenditures for Legacy Apartment 520 \$ 309.89 \$ 161								20,69
Total Annual Expenditures for Legacy Apartment 520 \$ 309.89 \$ 161	Fownship Expenditures Per Resident						\$	309.8
The Legacy Apartment - One-Time Utility Connection Revenue \$ 3.08	Fotal Annual Expenditures for Legacy Apartment		520	\$	309.89		\$	161,202.82
The Legacy Apartment - One-Time Utility Connection Revenue S 3.08	The Legent Anartment One Time Hally Com	mastion Davis						2 000 400
	•		е					3,080,400 964,113

APPENDIX B

CONCEPTUAL PUD PLANS



Hollies, Dogwood, etc.)


evergreen shrubs

perennials and/or seasonal


(Daylily, Sedum, Ornamental Grasses,

Black Eyed Susan, Coneflowers, etc...)

A Proposed Multi-Family Residential Community Genoa Township, Michigan

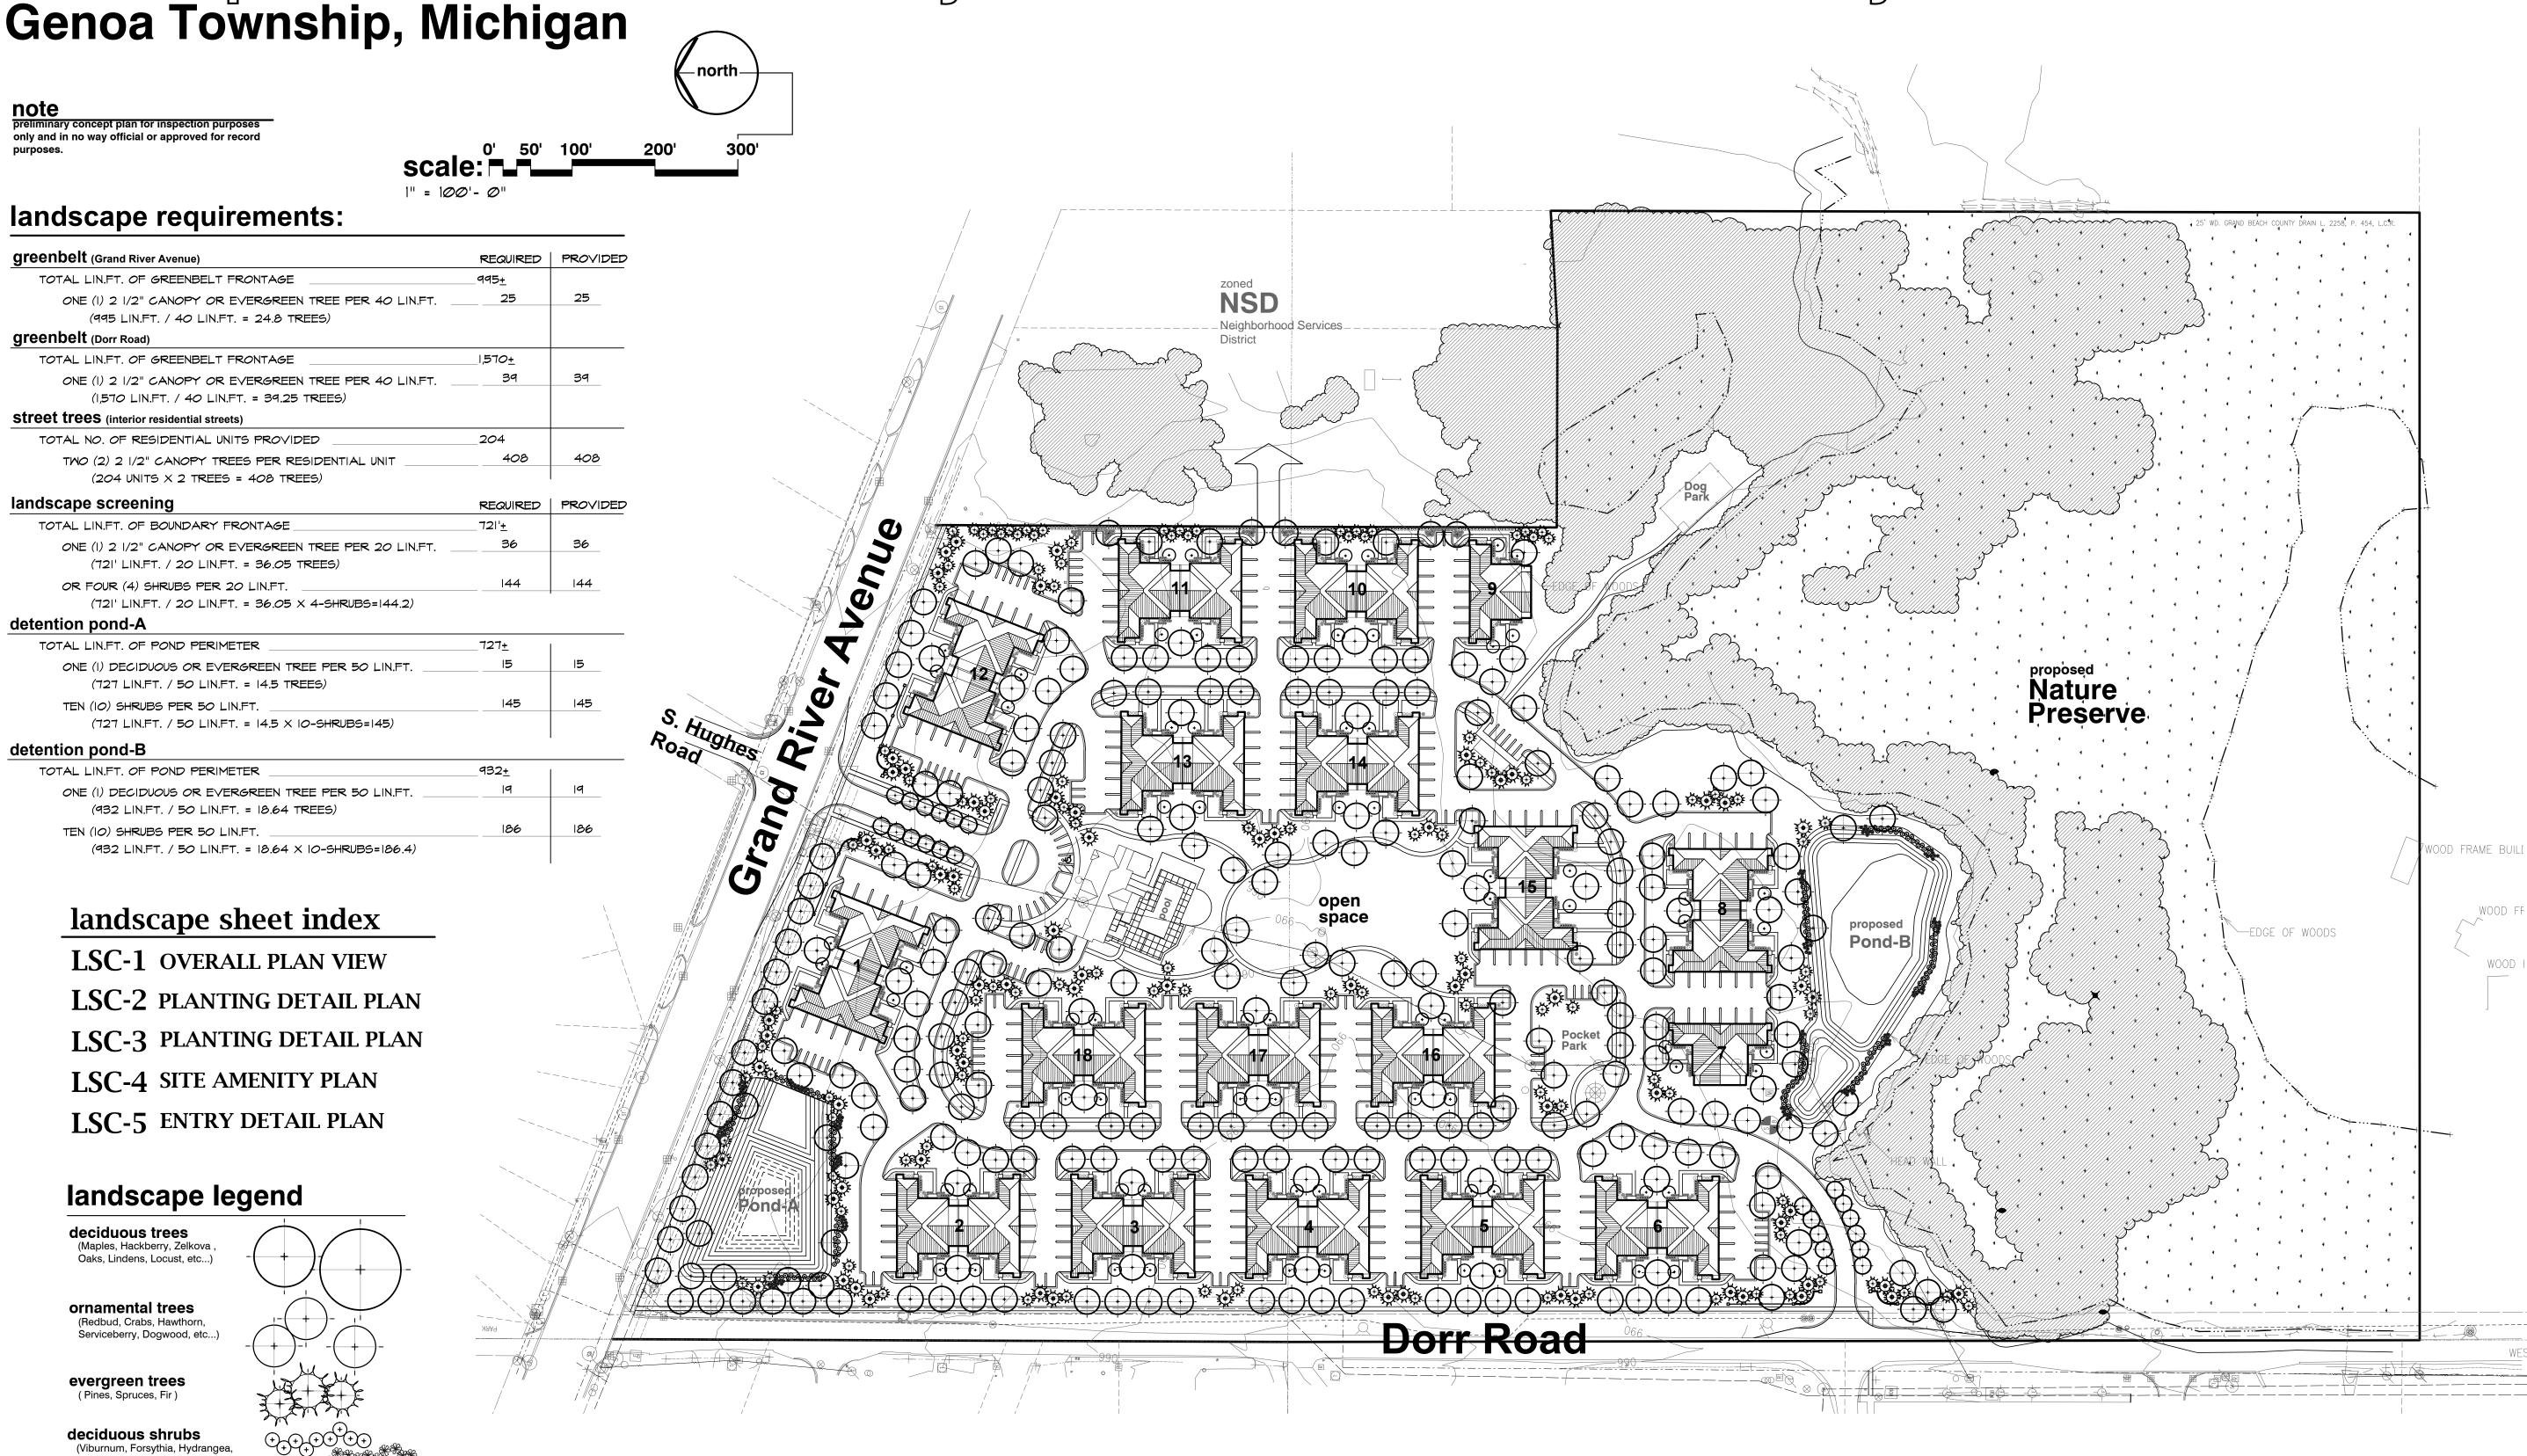



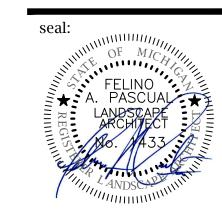

LAUTREC

31550 Northwestern HWY. Suite 200 Farmington Hills,

DORR ROAD AND GRAND RIVER AVE.

Michigan 48334

project location: Genoa Township, Michigan 12 Mile Road

sheet title:

CONCEPTUAL LANDSCAPE PLAN

job no./issue/revision date: LS21.096.08 SPA 8-18-2021 LS21.096.10 SPA 10-8-2021 LS21.096.10 SPA 10-24-2021 LS21.096.12 SPA 12-13-2021 LS22.028.02 SPA 2-24-2022 LS22.028.04 SPA 4-18-2022

drawn by: **JP, HP, DK**

checked by:

2-22-2022

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Do Not scale drawings. Use figured dimensions only




The location and elevations of existing exclusively responsible for determining the exact location and elevation prior to the start

project no:

LS22.028.02

sheet no: LSC-of

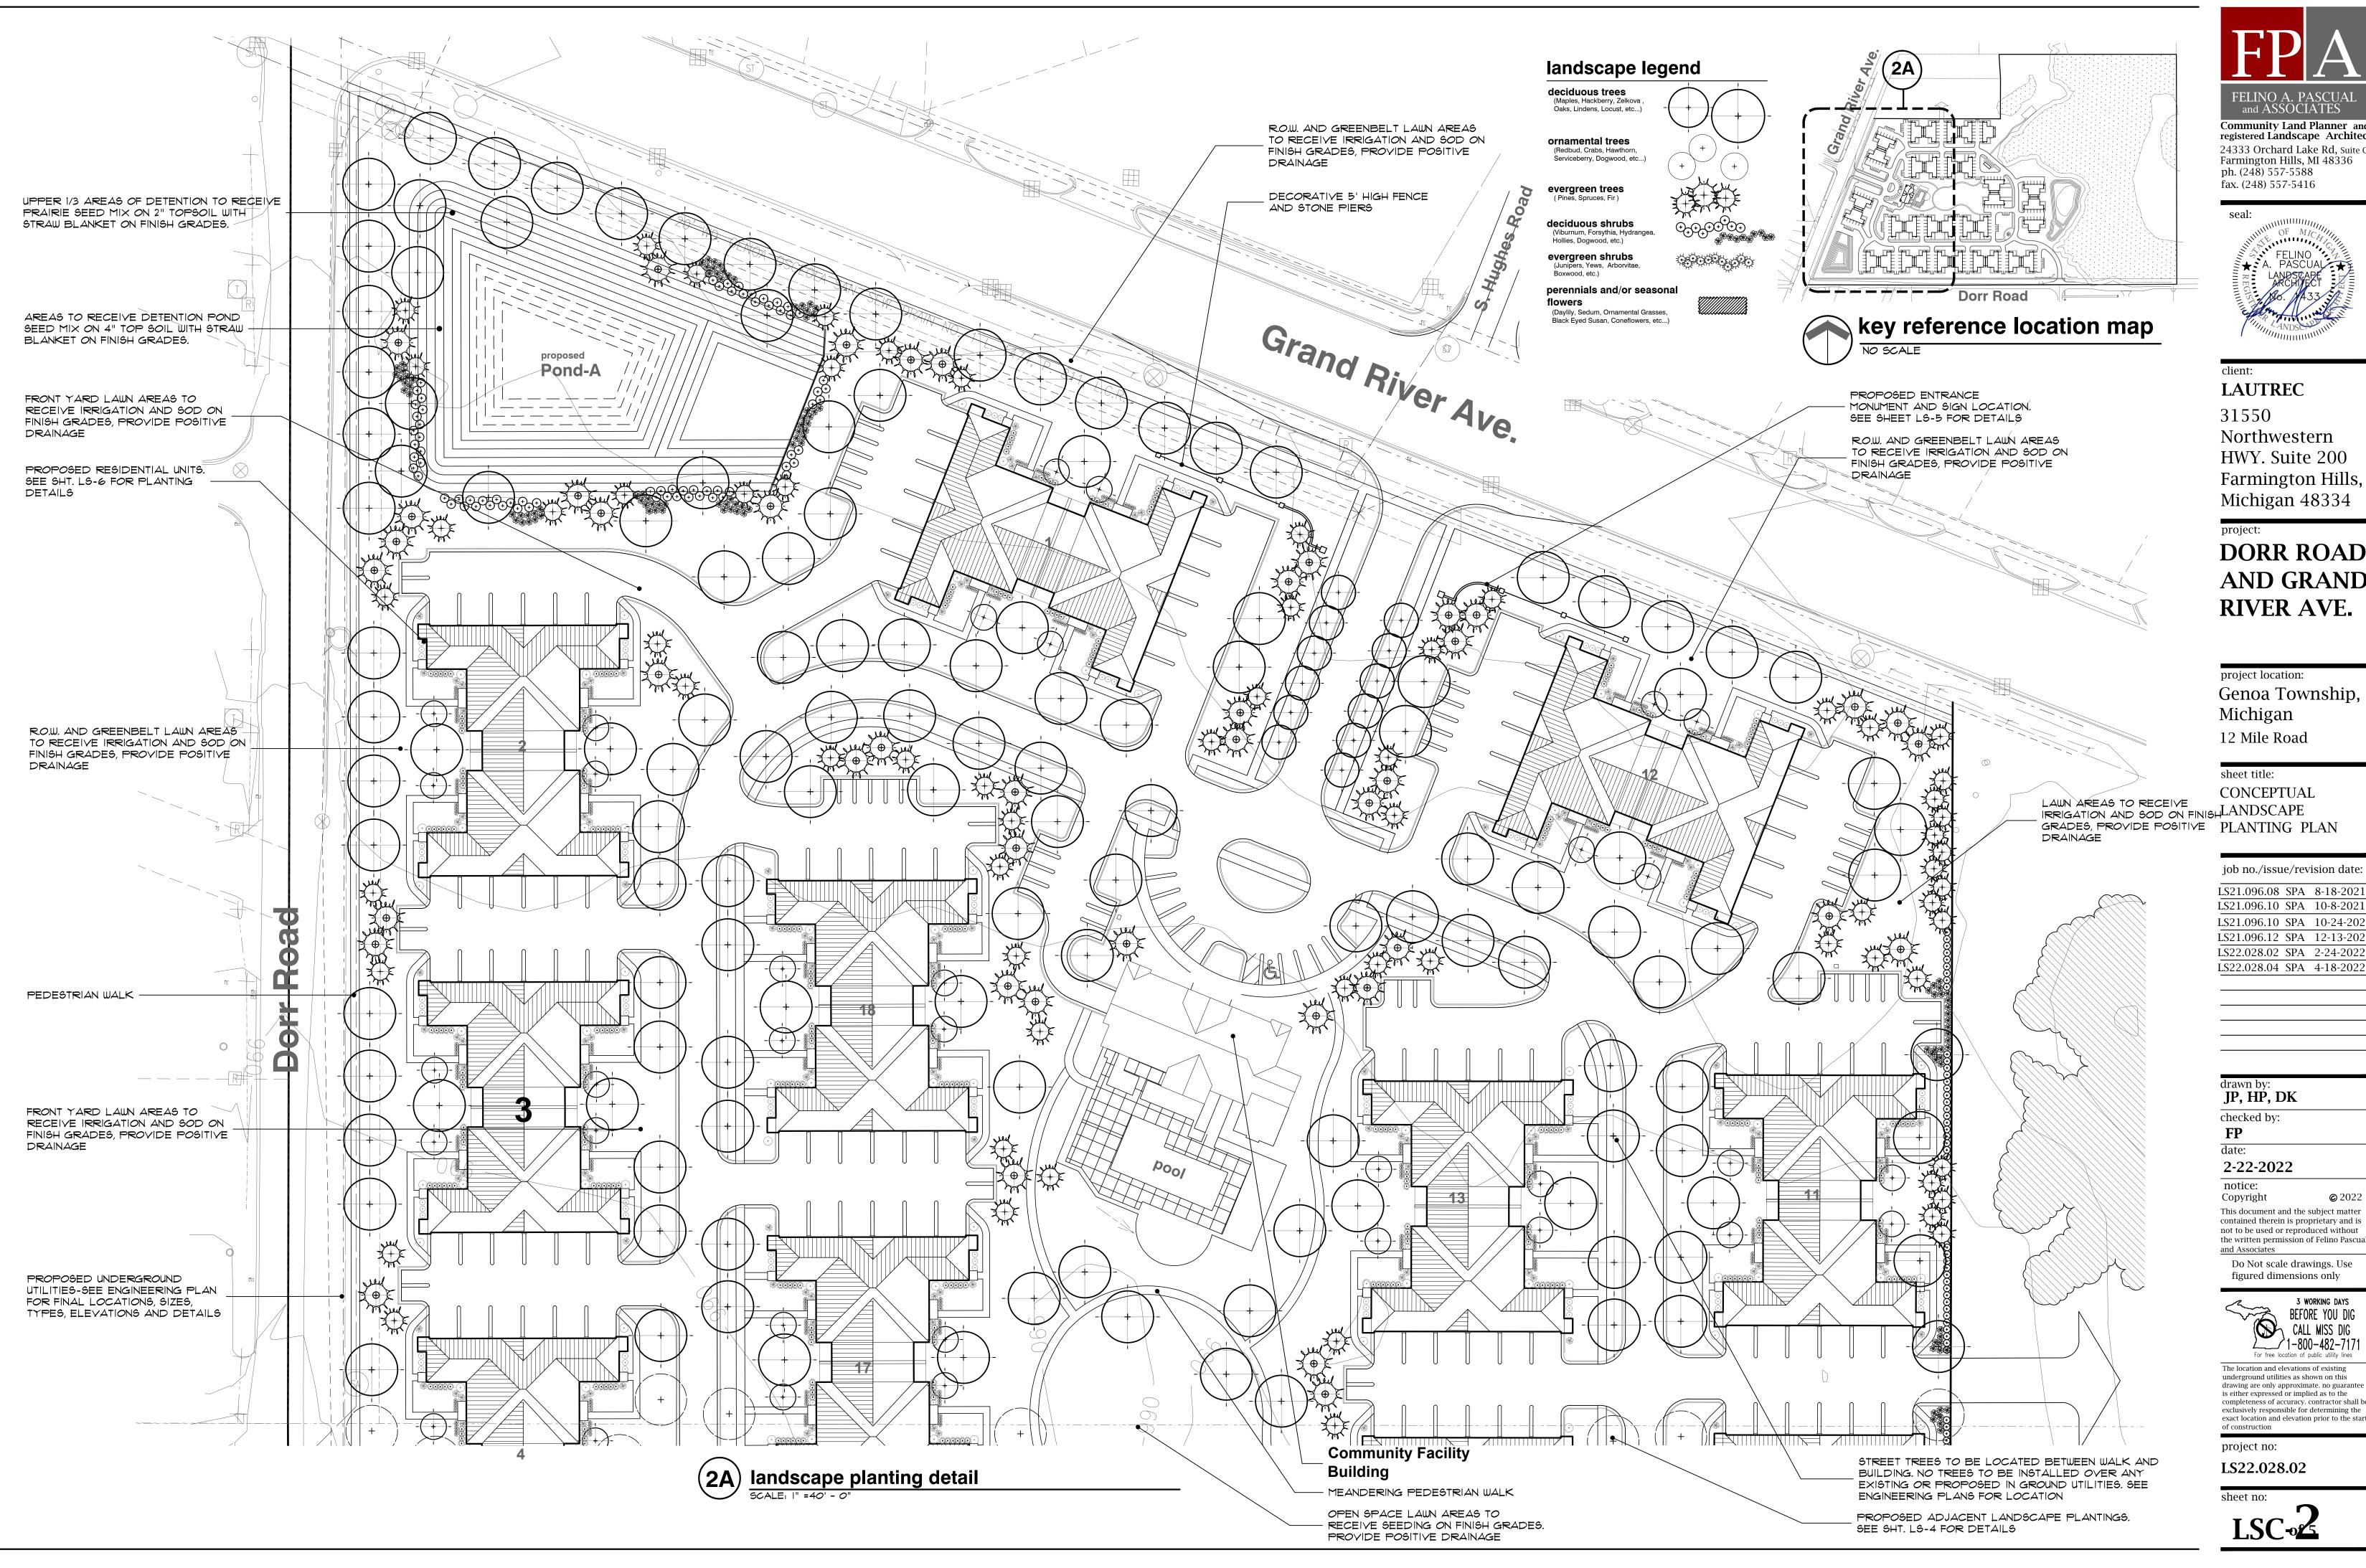





Northwestern HWY. Suite 200 Farmington Hills,

DORR ROAD **AND GRAND** RIVER AVE.

Genoa Township,


LS21.096.08 SPA 8-18-2021 LS21.096.10 SPA 10-8-2021 LS21.096.10 SPA 10-24-2021 LS21.096.12 SPA 12-13-2021 LS22.028.02 SPA 2-24-2022

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Do Not scale drawings. Use figured dimensions only

3 WORKING DAYS BEFORE YOU DIG CALL MISS DIG 1-800-482-7171

The location and elevations of existing underground utilities as shown on this is either expressed or implied as to the completeness of accuracy. contractor shall be exclusively responsible for determining the exact location and elevation prior to the start

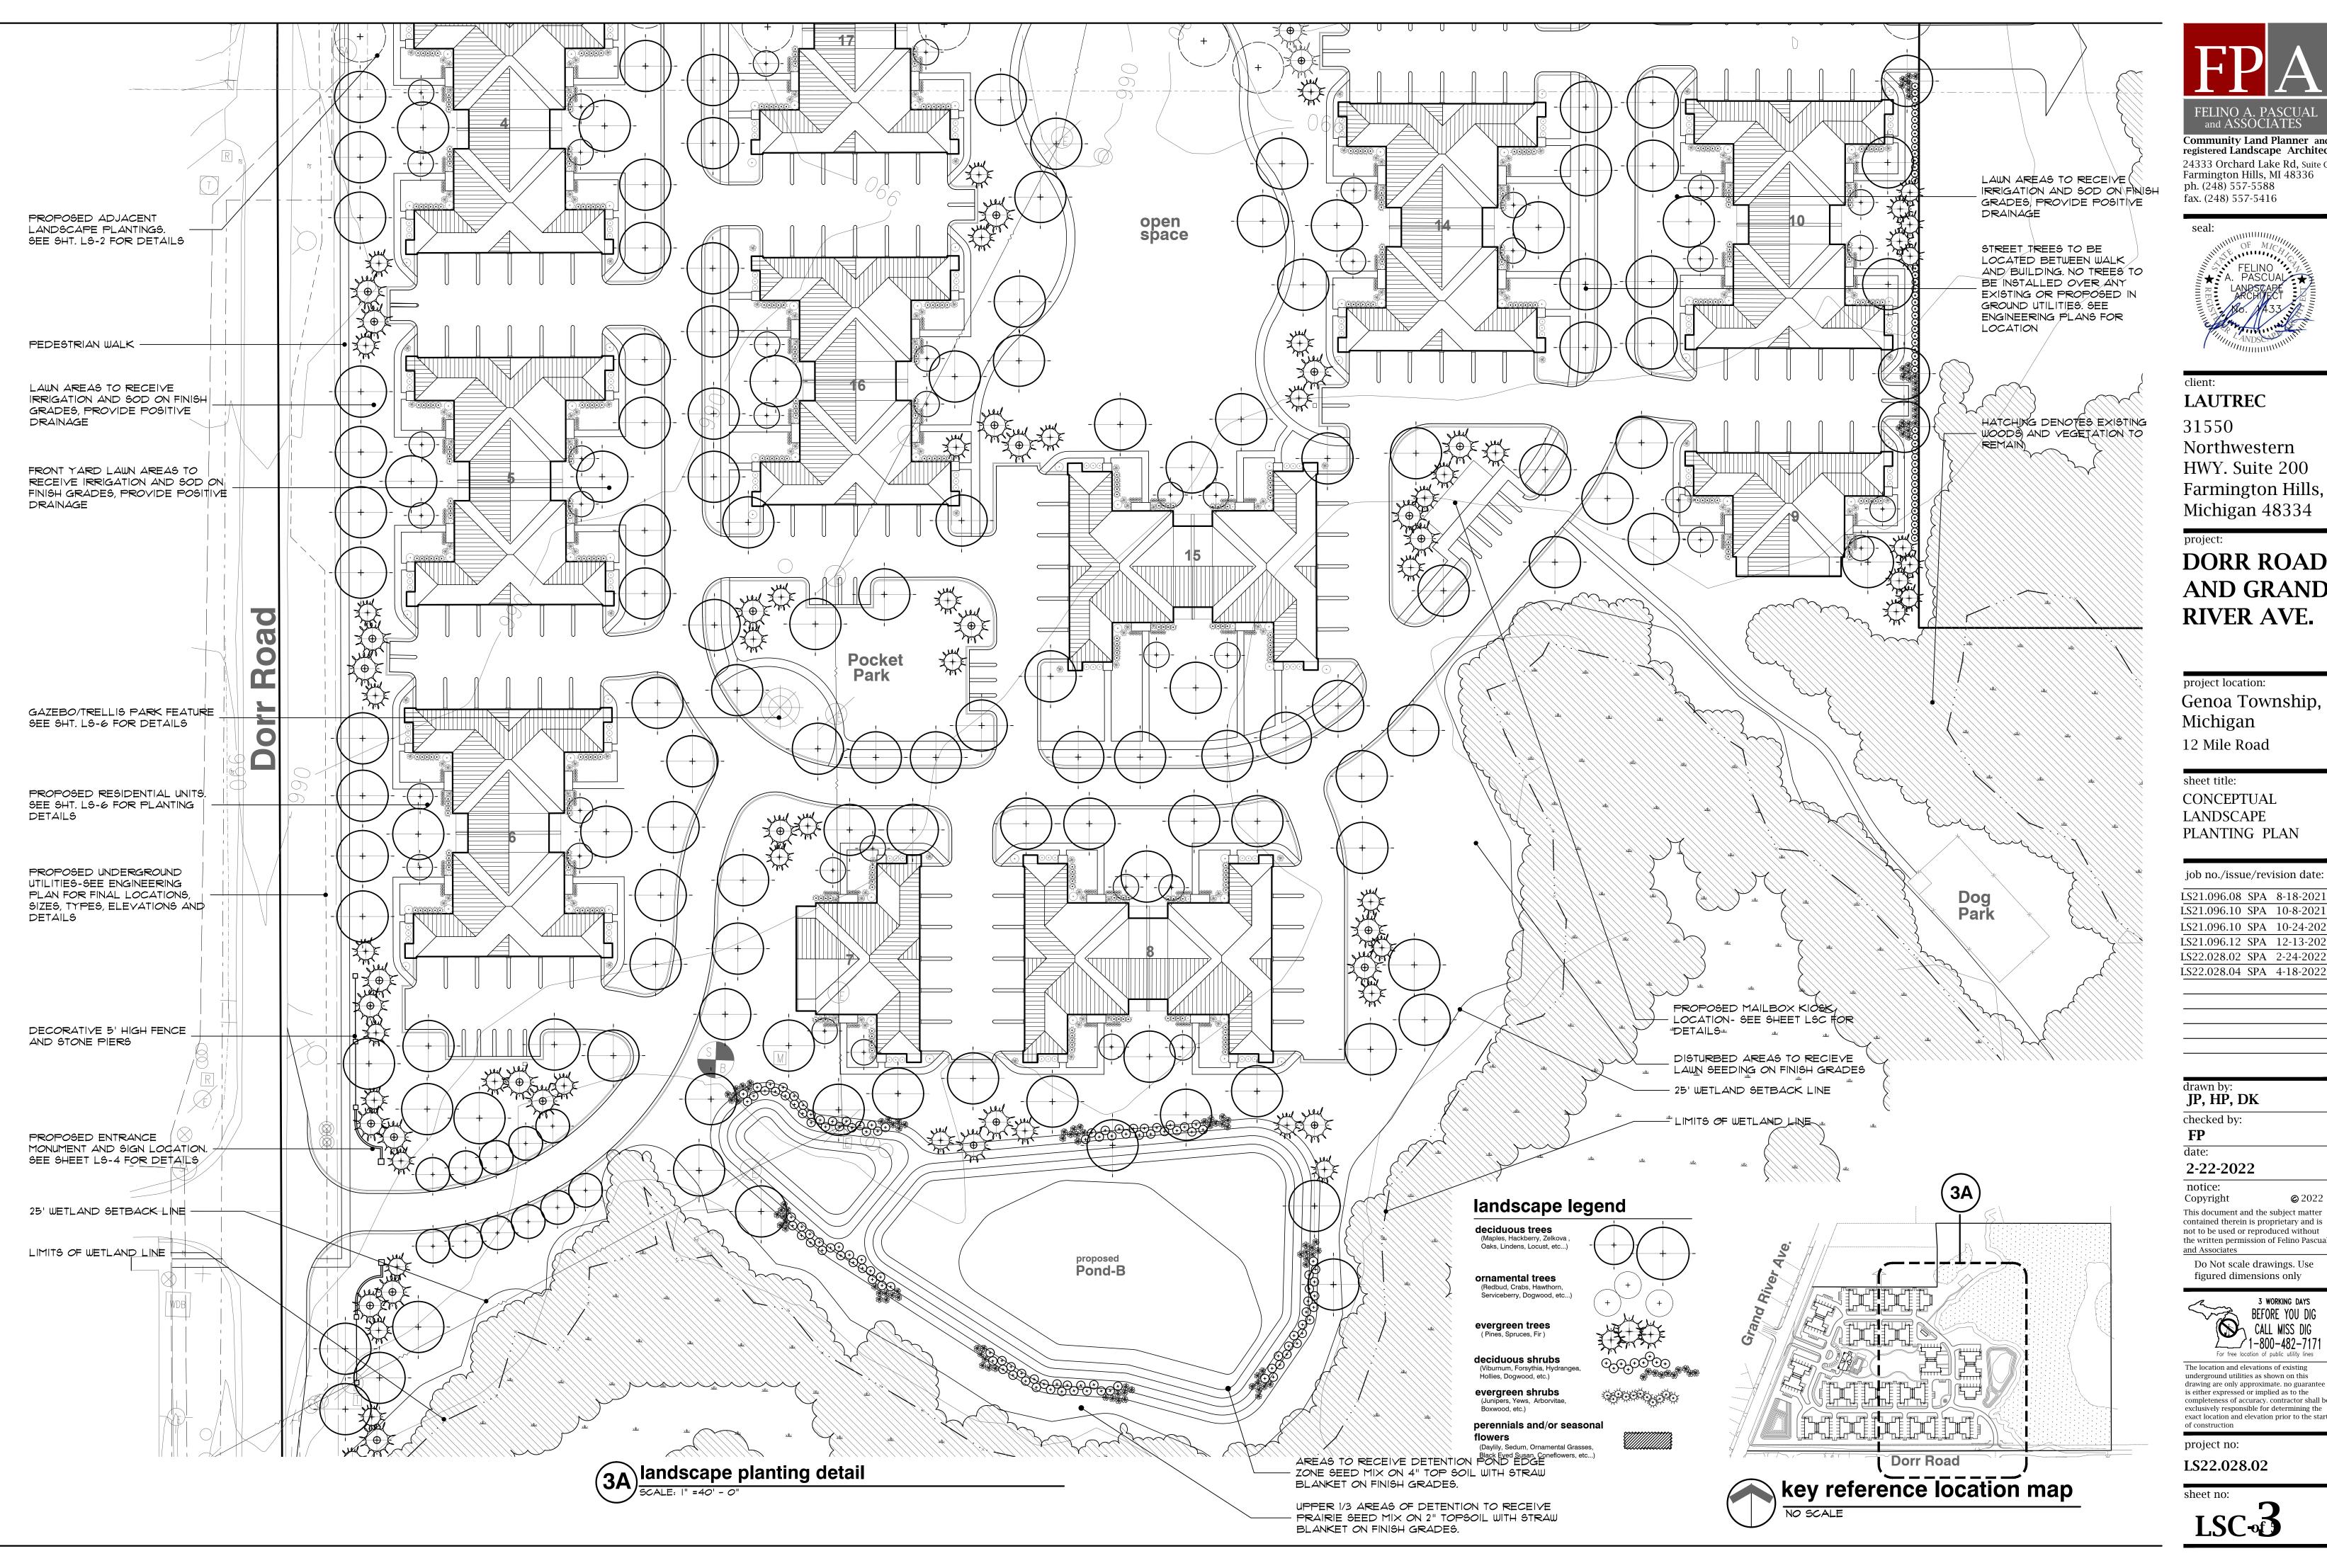

FELINO A. PASCUAL and ASSOCIATES Community Land Planner and registered Landscape Architect 24333 Orchard Lake Rd, Suite G Farmington Hills, MI 48336 ph. (248) 557-5588 fax. (248) 557-5416



LAUTREC

Northwestern HWY. Suite 200 Farmington Hills,

DORR ROAD **AND GRAND** RIVER AVE.

project location: Genoa Township, Michigan

12 Mile Road

sheet title: CONCEPTUAL LANDSCAPE

job no./issue/revision date:

LS21.096.08 SPA 8-18-2021 LS21.096.10 SPA 10-8-2021 LS21.096.10 SPA 10-24-2021 LS21.096.12 SPA 12-13-2021 LS22.028.02 SPA 2-24-2022

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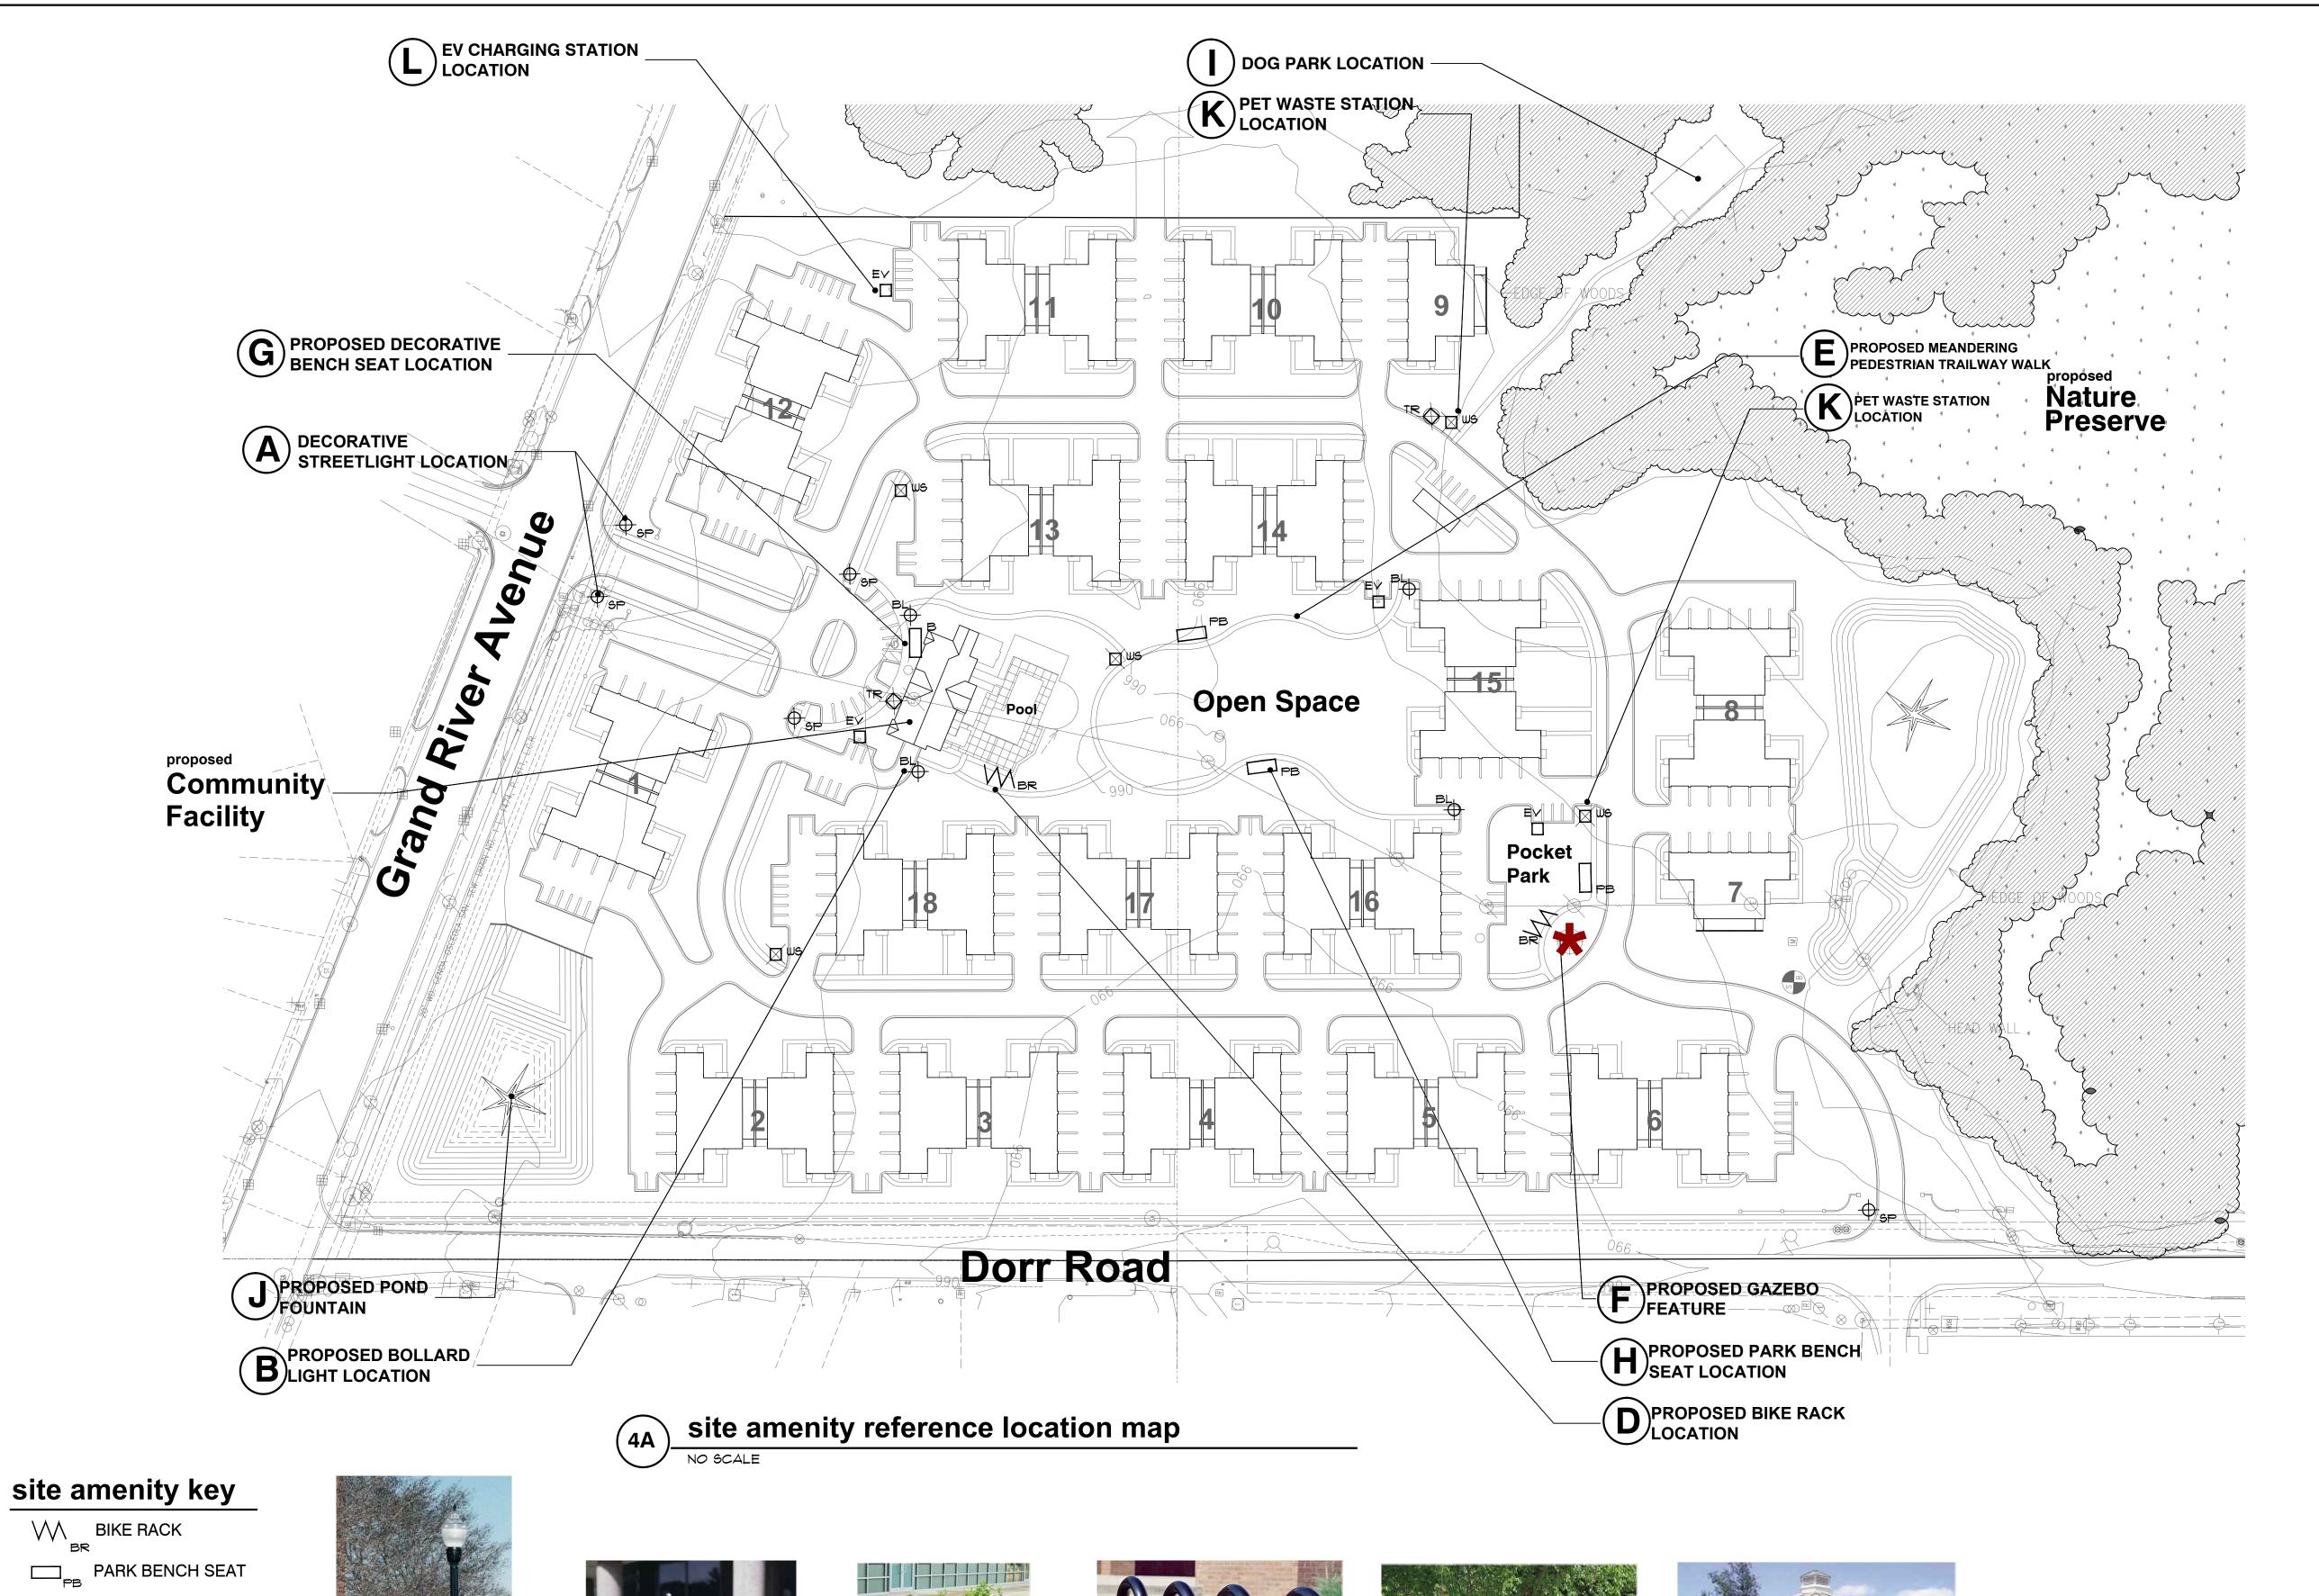
Do Not scale drawings. Use figured dimensions only

3 WORKING DAYS BEFORE YOU DIG CALL MISS DIG 1-800-482-7171

The location and elevations of existing is either expressed or implied as to the completeness of accuracy. contractor shall be exclusively responsible for determining the exact location and elevation prior to the start

LS22.028.02

LSC-05





EV charging station TOTAL OF 4-CONDITIONS



BY ZERO WASTE USA 12316 WORLD TRADE DRIVE #102 SAN DIEGO, CA. 92128 PH. 800-789-2563 WWW: ZEROWASTEUSA.COM

MODEL NO. JJB006-BLACK DESCRIPTION: SENTRY DOG WASTE STATION (73"H X 13"W)

pet waste station TOTAL OF 5-CONDITIONS



pond fountain OTAL OF 2-CONDITIONS



dog park



\park bench seating

TOTAL OF 3-CONDITIONS

JP, HP, DK

2-22-2022

the written permission of Felino Pascual

Do Not scale drawings. Use figured dimensions only



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project no:

sheet no:

₩ BIKE RACK PARK BENCH SEAT

> **BOLLARD LIGHT** ♦ STREET POLE LIGHT

GAZEBO or PERGOLA

M PET WASTE STATION TRASH RECEPTACLE

 $\square_{\scriptscriptstyle{\mathsf{EV}}}$ EV CHANGING STATION



A decorative pole and light

(5-CONDITION) DECORATIVE BLVD. ISLAND 8"DIA.X42" HST.) OR SITE FIXTURE LIGHTS AND EQUAL (4-CONDITIONS) ALUMINUM POLE.



bollard light BY LITHONIA LIGHTS OR EQUAL MODEL. DSXB LED (D-SERIES LED BOLLARD



trash receptacle 2-CONDITION) MANUFACTURED BY BY ANOVA, INC. WWW: ANOVAFURNISHINGS.COM


DESCRIPTION:32 GAL

FINISH: TEXTURE PEWTER



\ bicycle rack (2-CONDITIONS) BIKE RACK BY DUMOR, INC. MODEL NO. 130-20 (5-2 SURFACE PLATE MOUNT) 2 3/8" O.D. BLACK POWER-COATED

LOOP OR EQUAL

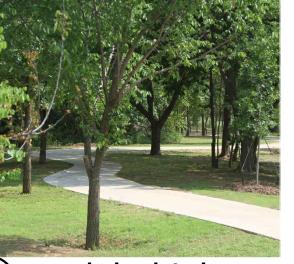

\meandering interior [/]pedestrian walk



gazebo feature I-CONDITIONS) STICK BUILT OR KIT FORM. TO BE BUILT BY MANUFACTURER STANDARDS



\ decorative bench seating TOTAL OF I-CONDITIONS MANUFACTURED BY BY ANOVA, INC. MMM: ANOVAFURNISHINGS.COM MODEL NO. LEXC6

FINISH: TEXTURE PEWTER

DESCRIPTION: 6' WIDE CONTOUR BENCH

6' WIDE PARK BENCH SEAT BY DUMOR, INC. MODEL NO. 34-60D (S-I) SUPPORT: S-I EMBEDMENT FINISH: BLACK POWER-COATED



LAUTREC 31550

Northwestern HWY. Suite 200 Farmington Hills, Michigan 48334

FELINO A. PASCUA and ASSOCIATES

Community Land Planner and registered Landscape Architect

24333 Orchard Lake Rd, Suite G Farmington Hills, MI 48336 ph. (248) 557-5588 fax. (248) 557-5416

project: **DORR ROAD** AND GRAND RIVER AVE.

project location: Genoa Township, Michigan

12 Mile Road

sheet title:

CONCEPTUAL SITE AMENITY PLAN

job no./issue/revision date:


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checked by:


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LS22.028.02

LSC-4 of 5





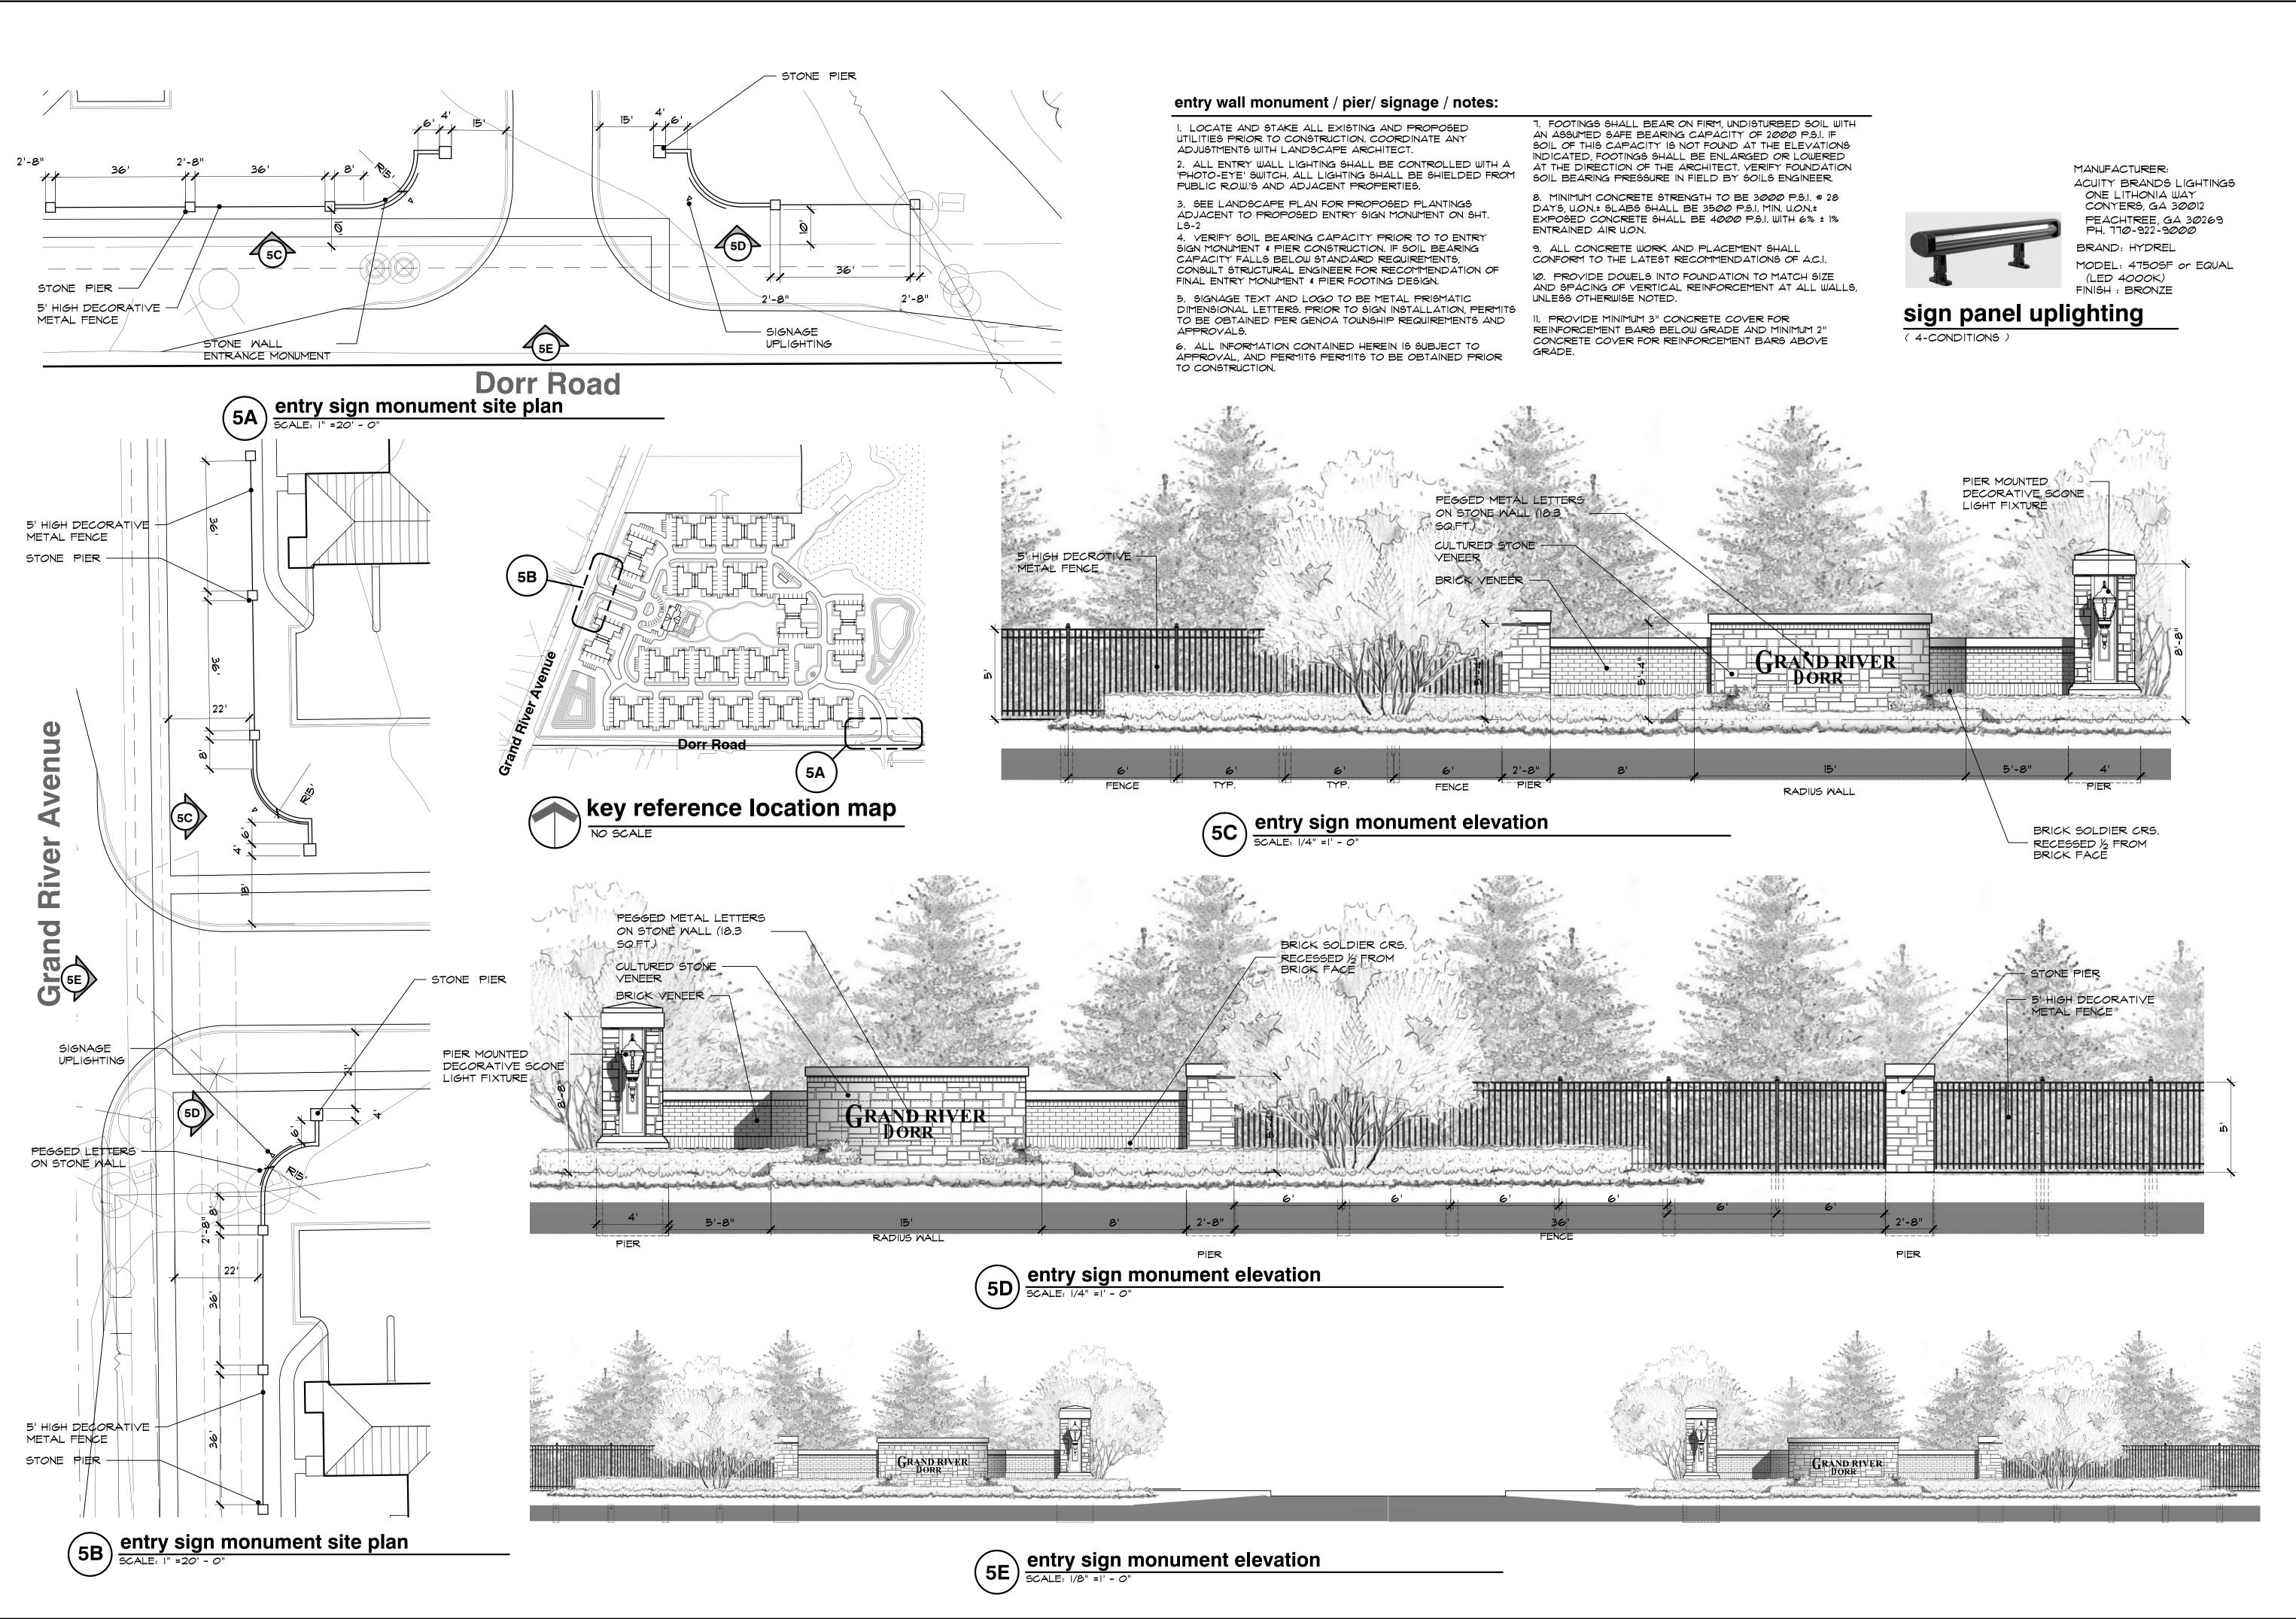

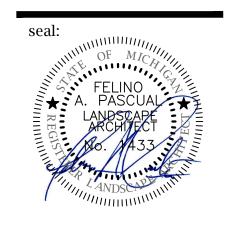client: **LAUTREC**

31550 Northwestern HWY. Suite 200 Farmington Hills,

Michigan 48334

project:

DORR ROAD AND GRAND RIVER AVE.

project location:
Genoa Township,
Michigan
12 Mile Road

sheet title:

CONCEPTUAL ENTRY SIGN MONUMENT

job no./issue/revision date:

LS21.096.08 SPA 8-18-2021
LS21.096.10 SPA 10-8-2021
LS21.096.10 SPA 10-24-2021
LS21.096.12 SPA 12-13-2021
LS22.028.02 SPA 2-24-2022

LS22.028.04 SPA 4-18-2022

drawn by: **JP, HP, DK**

checked by:

FP

2-22-2022

notice:

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project no:

LS22.028.02


sheet no:

LSC-5 of 5

20

THE LEGACY APARTMENT HOMES

6080 W. GRAND RIVER GENOA TOWNSHIP, LIVINGSTON COUNTY

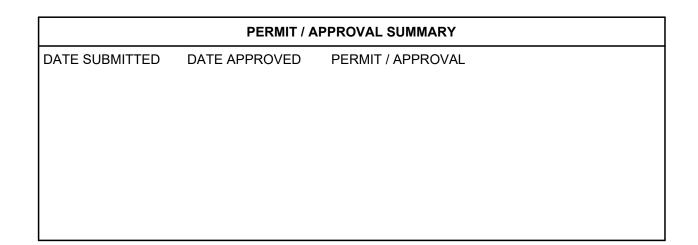



INDEX OF DRAWINGS						
SHEET NUMBER	SHEET TITLE					
C-0.0	COVER SHEET					
C-1.1	TOPOGRAPHICAL SURVEY-OVERALL					
C-1.2	TOPOGRAPHICAL SURVEY-NORTH					
C-1.3	TOPOGRAPHICAL SURVEY-SOUTH					
C-1.4	TREE LIST					
C-2.1	OVERALL PUD SITE PLAN					
C-2.2	CONCEPTUAL PUD SITE PLAN-NORTH					
C-2.3	CONCEPTUAL PUD SITE PLAN-SOUTH					
C-3.1	CONCEPTUAL STORM WATER MANAGEMENT PLAN					
C-4.1	CONCEPTUAL UTILITY PLAN					
C-4.2	CONCEPTUAL UTILITY PLAN					
C-5.1	VEHICLE TRACKING					
L-1.0 - 5.0	CONCEPTUAL LANDSCAPE PLAN					
A -1.0 - 6.0	ARCHITECTURAL FLOOR PLANS AND ELEVATIONS					



DESIGN TEAM

OWNER/APPLICANT/DEVELOPER

PEA GROUP GRAND RIVER DORR, LLC 315550 NORTHWESTERN HIGHWAY 7927 NEMCO WAY, STE. 115 FARMINGTON HILL, MI 48334 BRIGHTON, MI 48116 CONTACT: MARK KASSAB CONTACT: JONATHAN E. CURRY, PE PHONE:248.865.0066 PHONE: 844.813.2949 EMAIL: MKASSAB@MSHAPIROREALESTATE.COM EMAIL: JCURRY@PEAGROUP.COM

SURVEYOR

HUBBELL ROTH AND CLARK 555 HULET DRIVE BLOOMFIELD HILLS, MICHIGAN 48303 CONTACT: MELISSA COATTE, P.E. PHONE:248-454-6300 EMAIL: mcoatta@hrcengr.com

CIVIL ENGINEER

LANDSCAPE ARCHITECT/PLANNER


FELINO A. PASCUAL AND ASSOCIATES 24333 ORCHARD LAKE ROAD SUITE G CONTACT: FELINO A. PASCUAL, RLA, CLARB PHONE: 248.557.5588


ARCHITECT


BURMANN ASSOCIATES INC. 119 W. ST. CLAIR ROMEO, MICHIGAN 58065-4655 PHONE: 586.752.5010 , MOBILE: 586.201.1602 EMAIL: GREATARCHITECTS@CHARTER.NET

GROUP

REVISIONS			
DESCRIPTION	DATE		
ORIGINAL ISSUE DATE	5/24/2022		
REVISED FOR TOWNSHIP COMMENTS	6/23/2022		

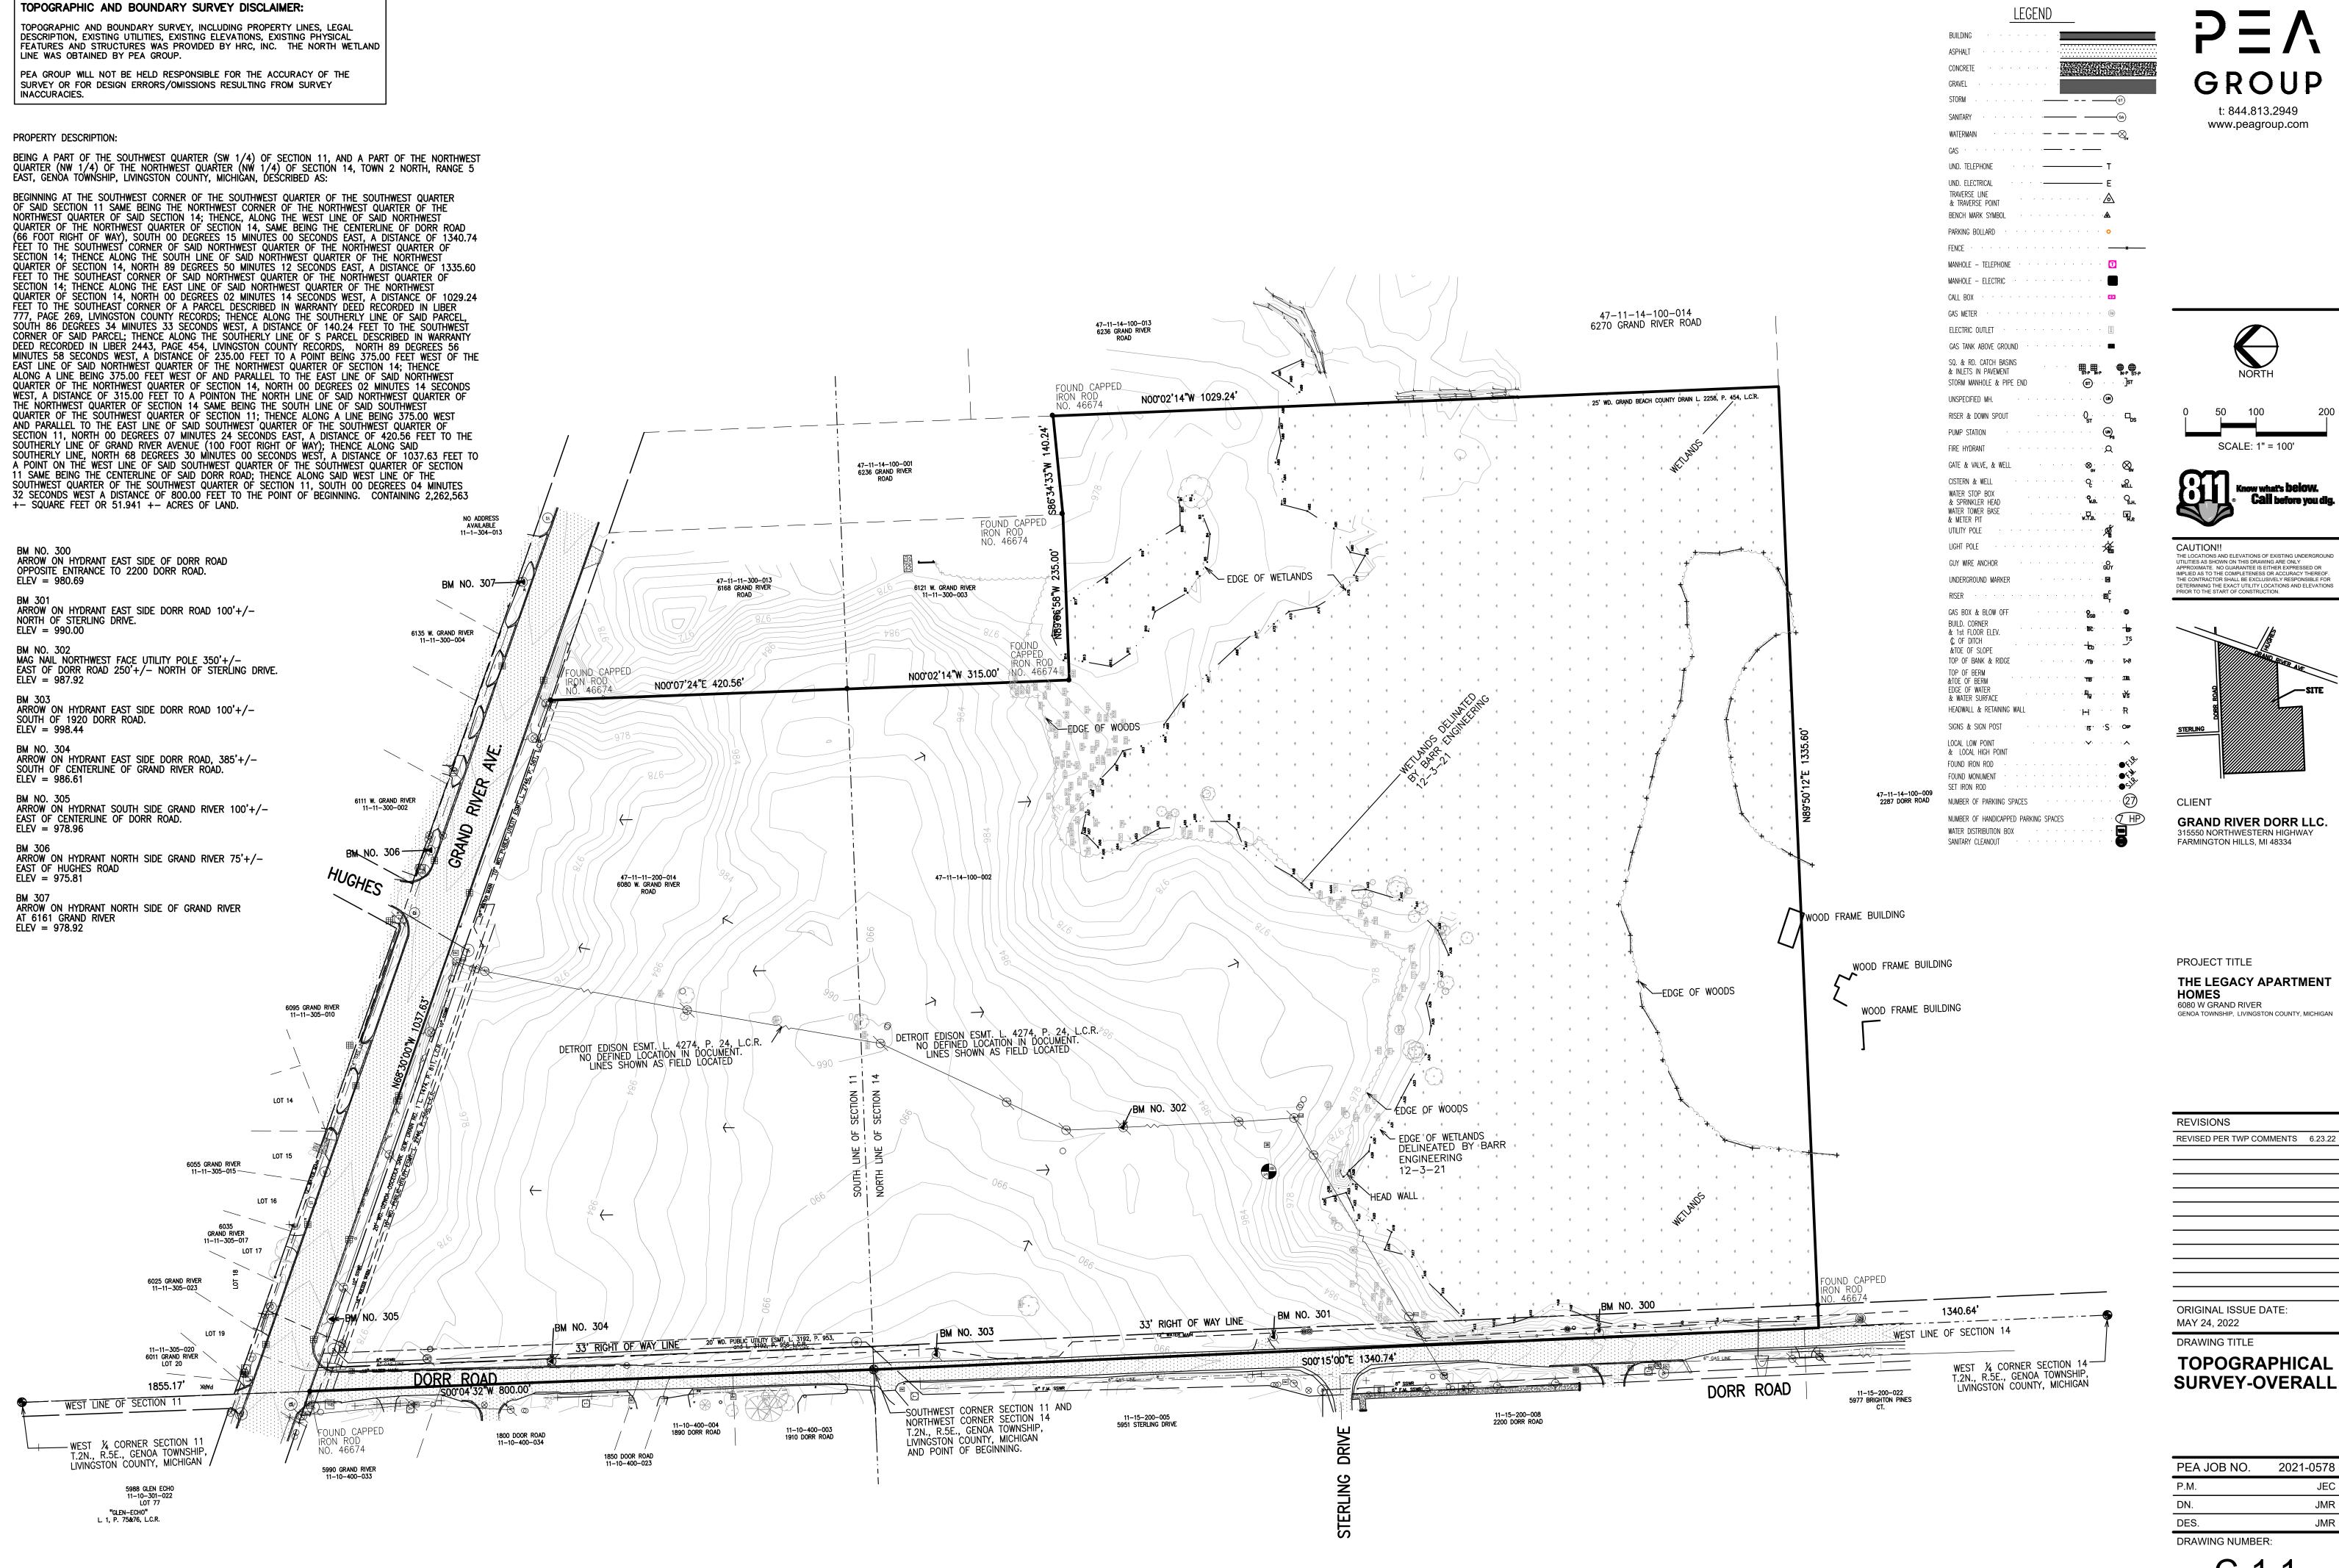

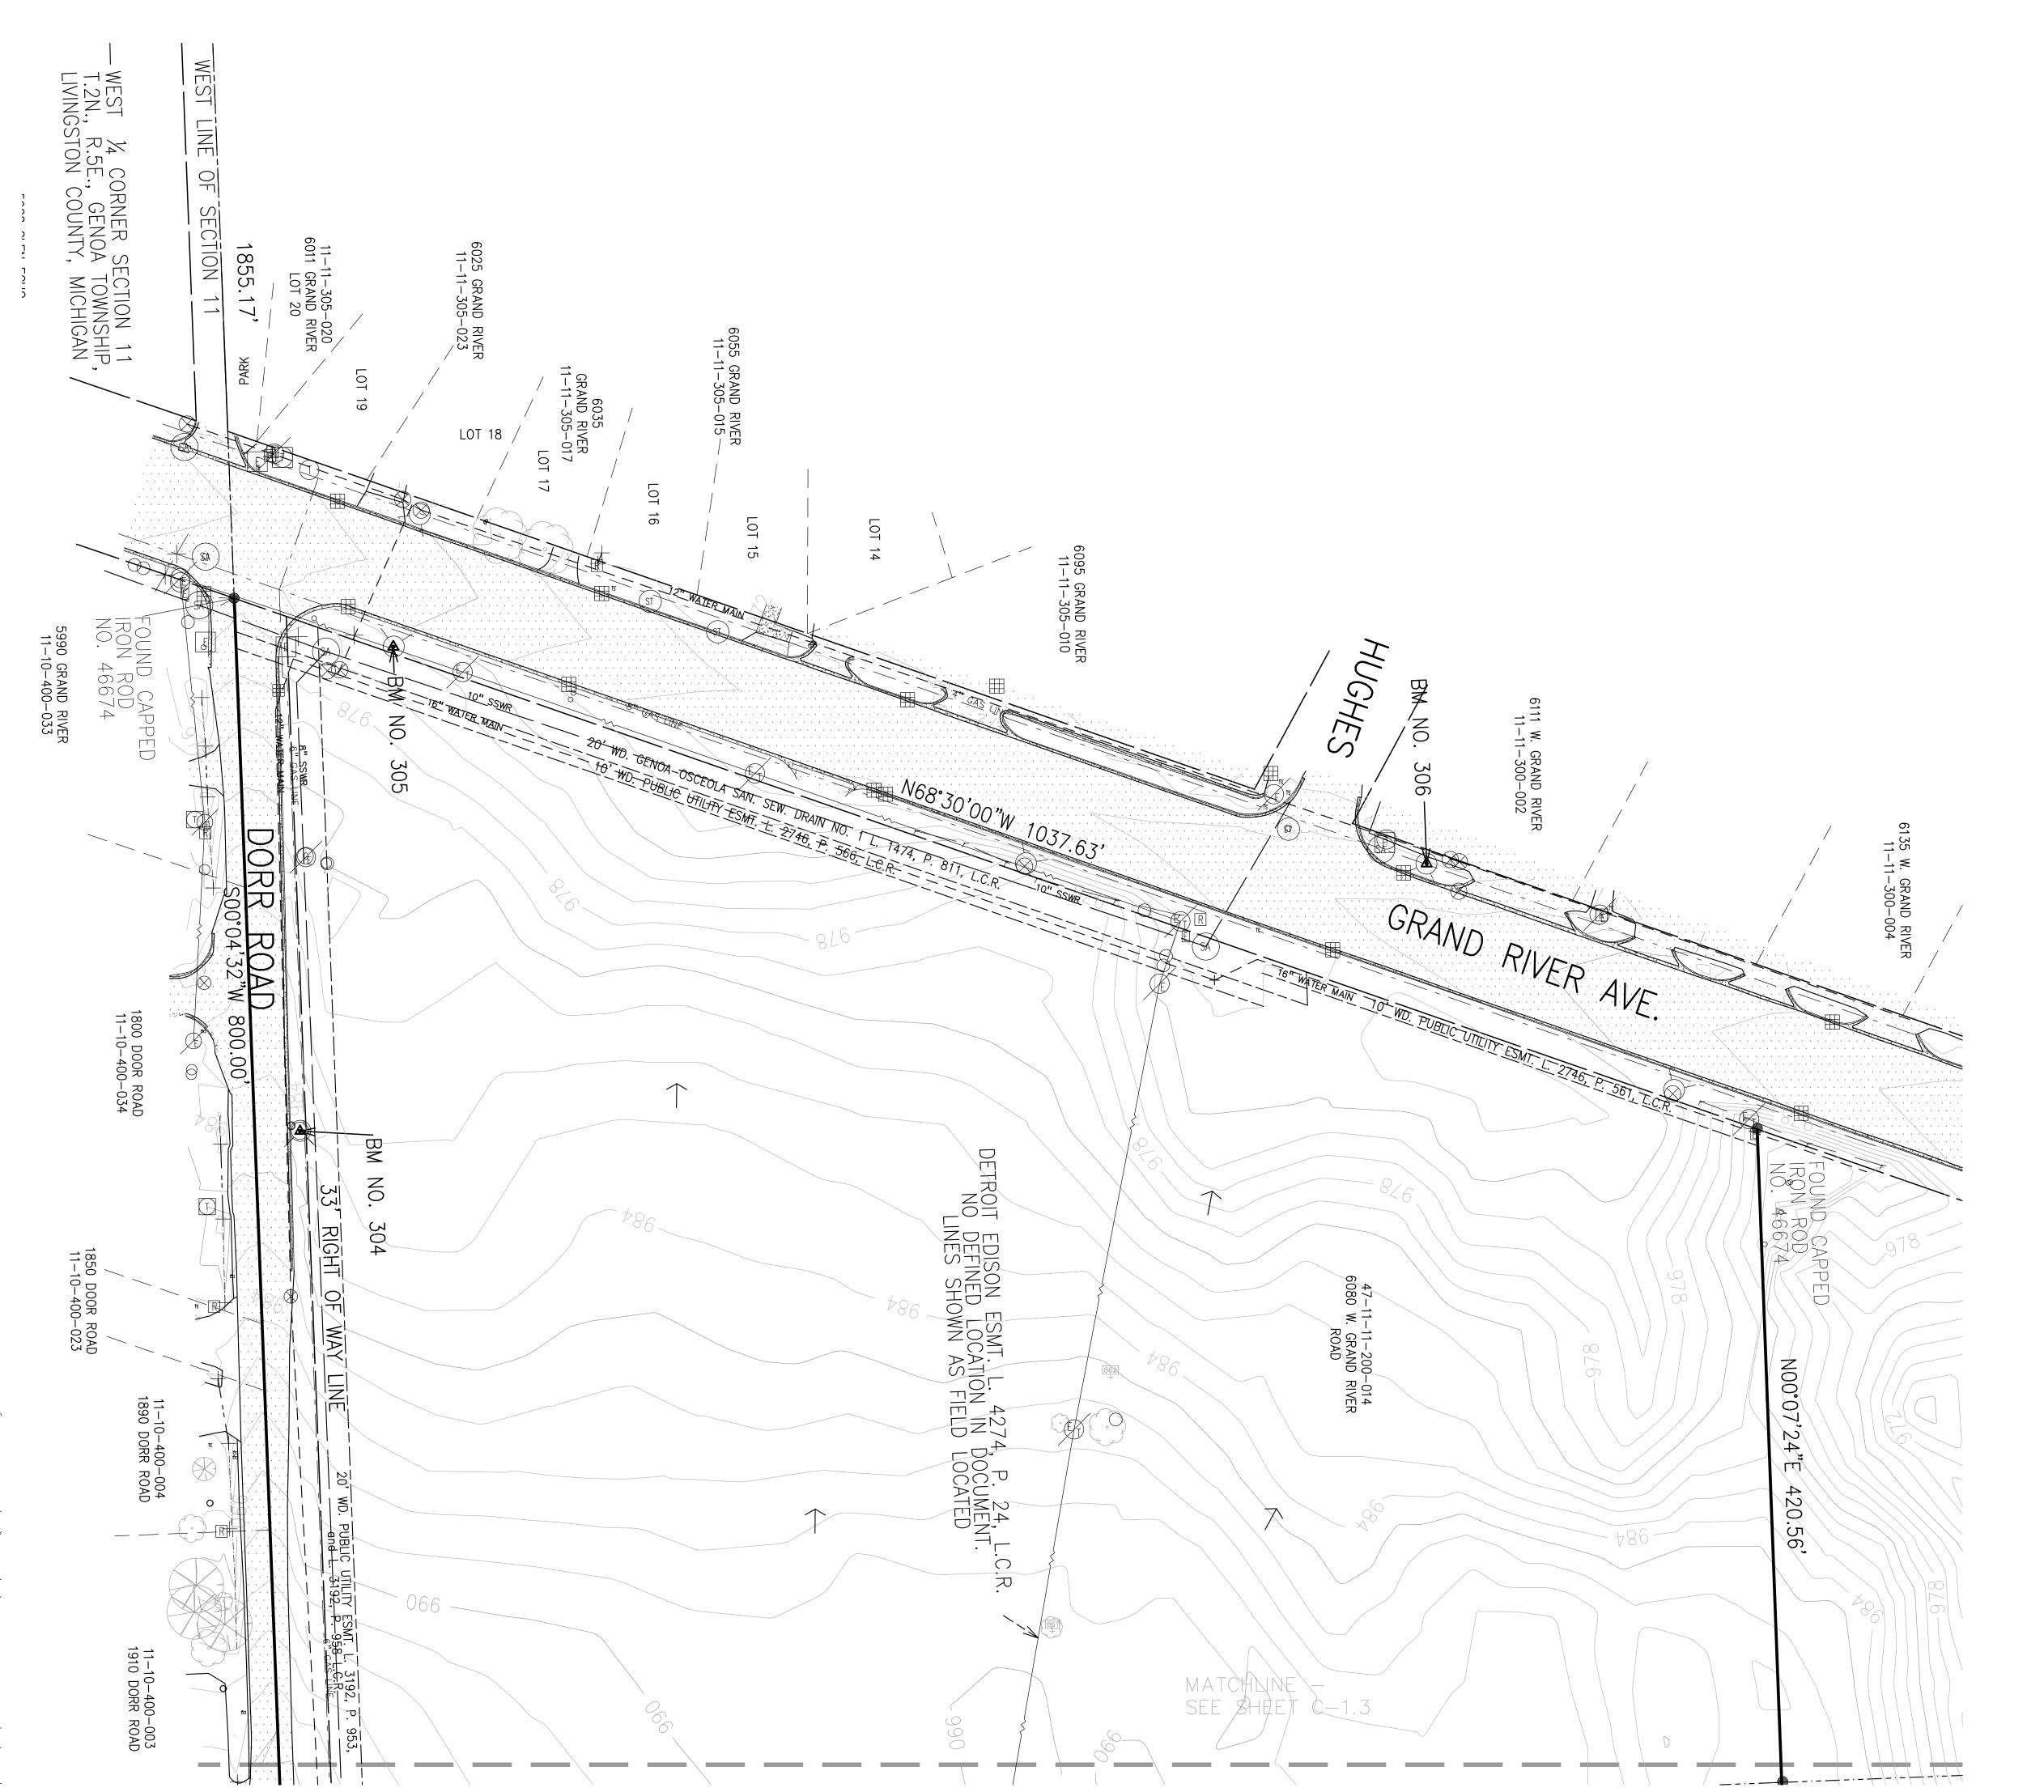

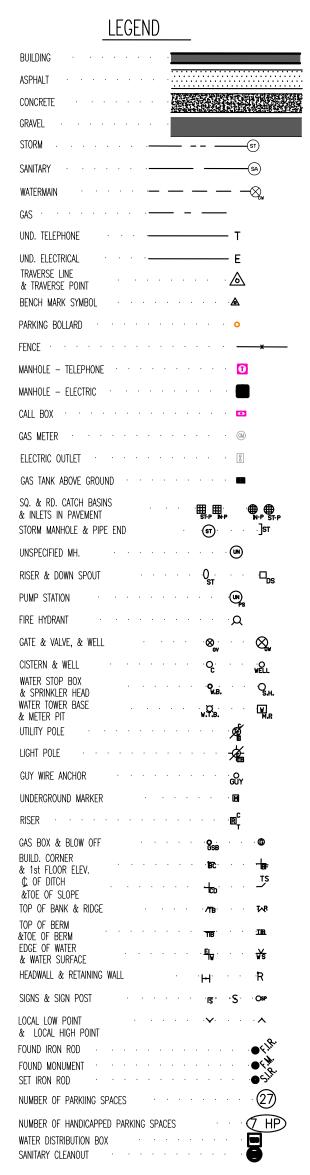

PEA
GROUP

1: 844.813.2949
www.peagroup.com

2: 844.813.2949
www.peagroup.

BM NO. 300
ARROW ON HYDRANT EAST SIDE OF DORR ROAD
OPPOSITE ENTRANCE TO 2200 DORR ROAD.
ELEV = 980.69

BM 301 ARROW ON HYDRANT EAST SIDE DORR ROAD 100'+/-NORTH OF STERLING DRIVE. ELEV = 990.00

BM NO. 302
MAG NAIL NORTHWEST FACE UTILITY POLE 350'+/EAST OF DORR ROAD 250'+/- NORTH OF STERLING DRIVE.
ELEV = 987.92

BM 303 ARROW ON HYDRANT EAST SIDE DORR ROAD 100'+/-SOUTH OF 1920 DORR ROAD. ELEV = 998.44

BM NO. 304
ARROW ON HYDRANT EAST SIDE DORR ROAD, 385'+/SOUTH OF CENTERLINE OF GRAND RIVER ROAD.
ELEV = 986.61

BM NO. 305 ARROW ON HYDRNAT SOUTH SIDE GRAND RIVER 100'+/-EAST OF CENTERLINE OF DORR ROAD. ELEV = 978.96

BM 306 ARROW ON HYDRANT NORTH SIDE GRAND RIVER 75'+/-EAST OF HUGHES ROAD ELEV = 975.81

BM 307 ARROW ON HYDRANT NORTH SIDE OF GRAND RIVER AT 6161 GRAND RIVER ELEV = 978.92

PROJECT TITLE
THE LEGACY APARTMEN HOMES
6080 W GRAND RIVER
GENOA TOWNSHIP. LIVINGSTON COUNTY, MICHI

GRAND RIVER DORR LLC.

315550 NORTHWESTERN HIGHWAY

FARMINGTON HILLS, MI 48334

CLIENT


REVISIONS	
REVISED PER TWP COMMENTS	6.23.22

ORIGINAL ISSUE DATE: MAY 24, 2022

TOPOGRA

TOPOGRAPHICAL SURVEY-NORTH

PEA JOB NO.	2021-0578
P.M.	JEC
DN.	JMR
DES.	JMR
DRAWING NUMBER:	

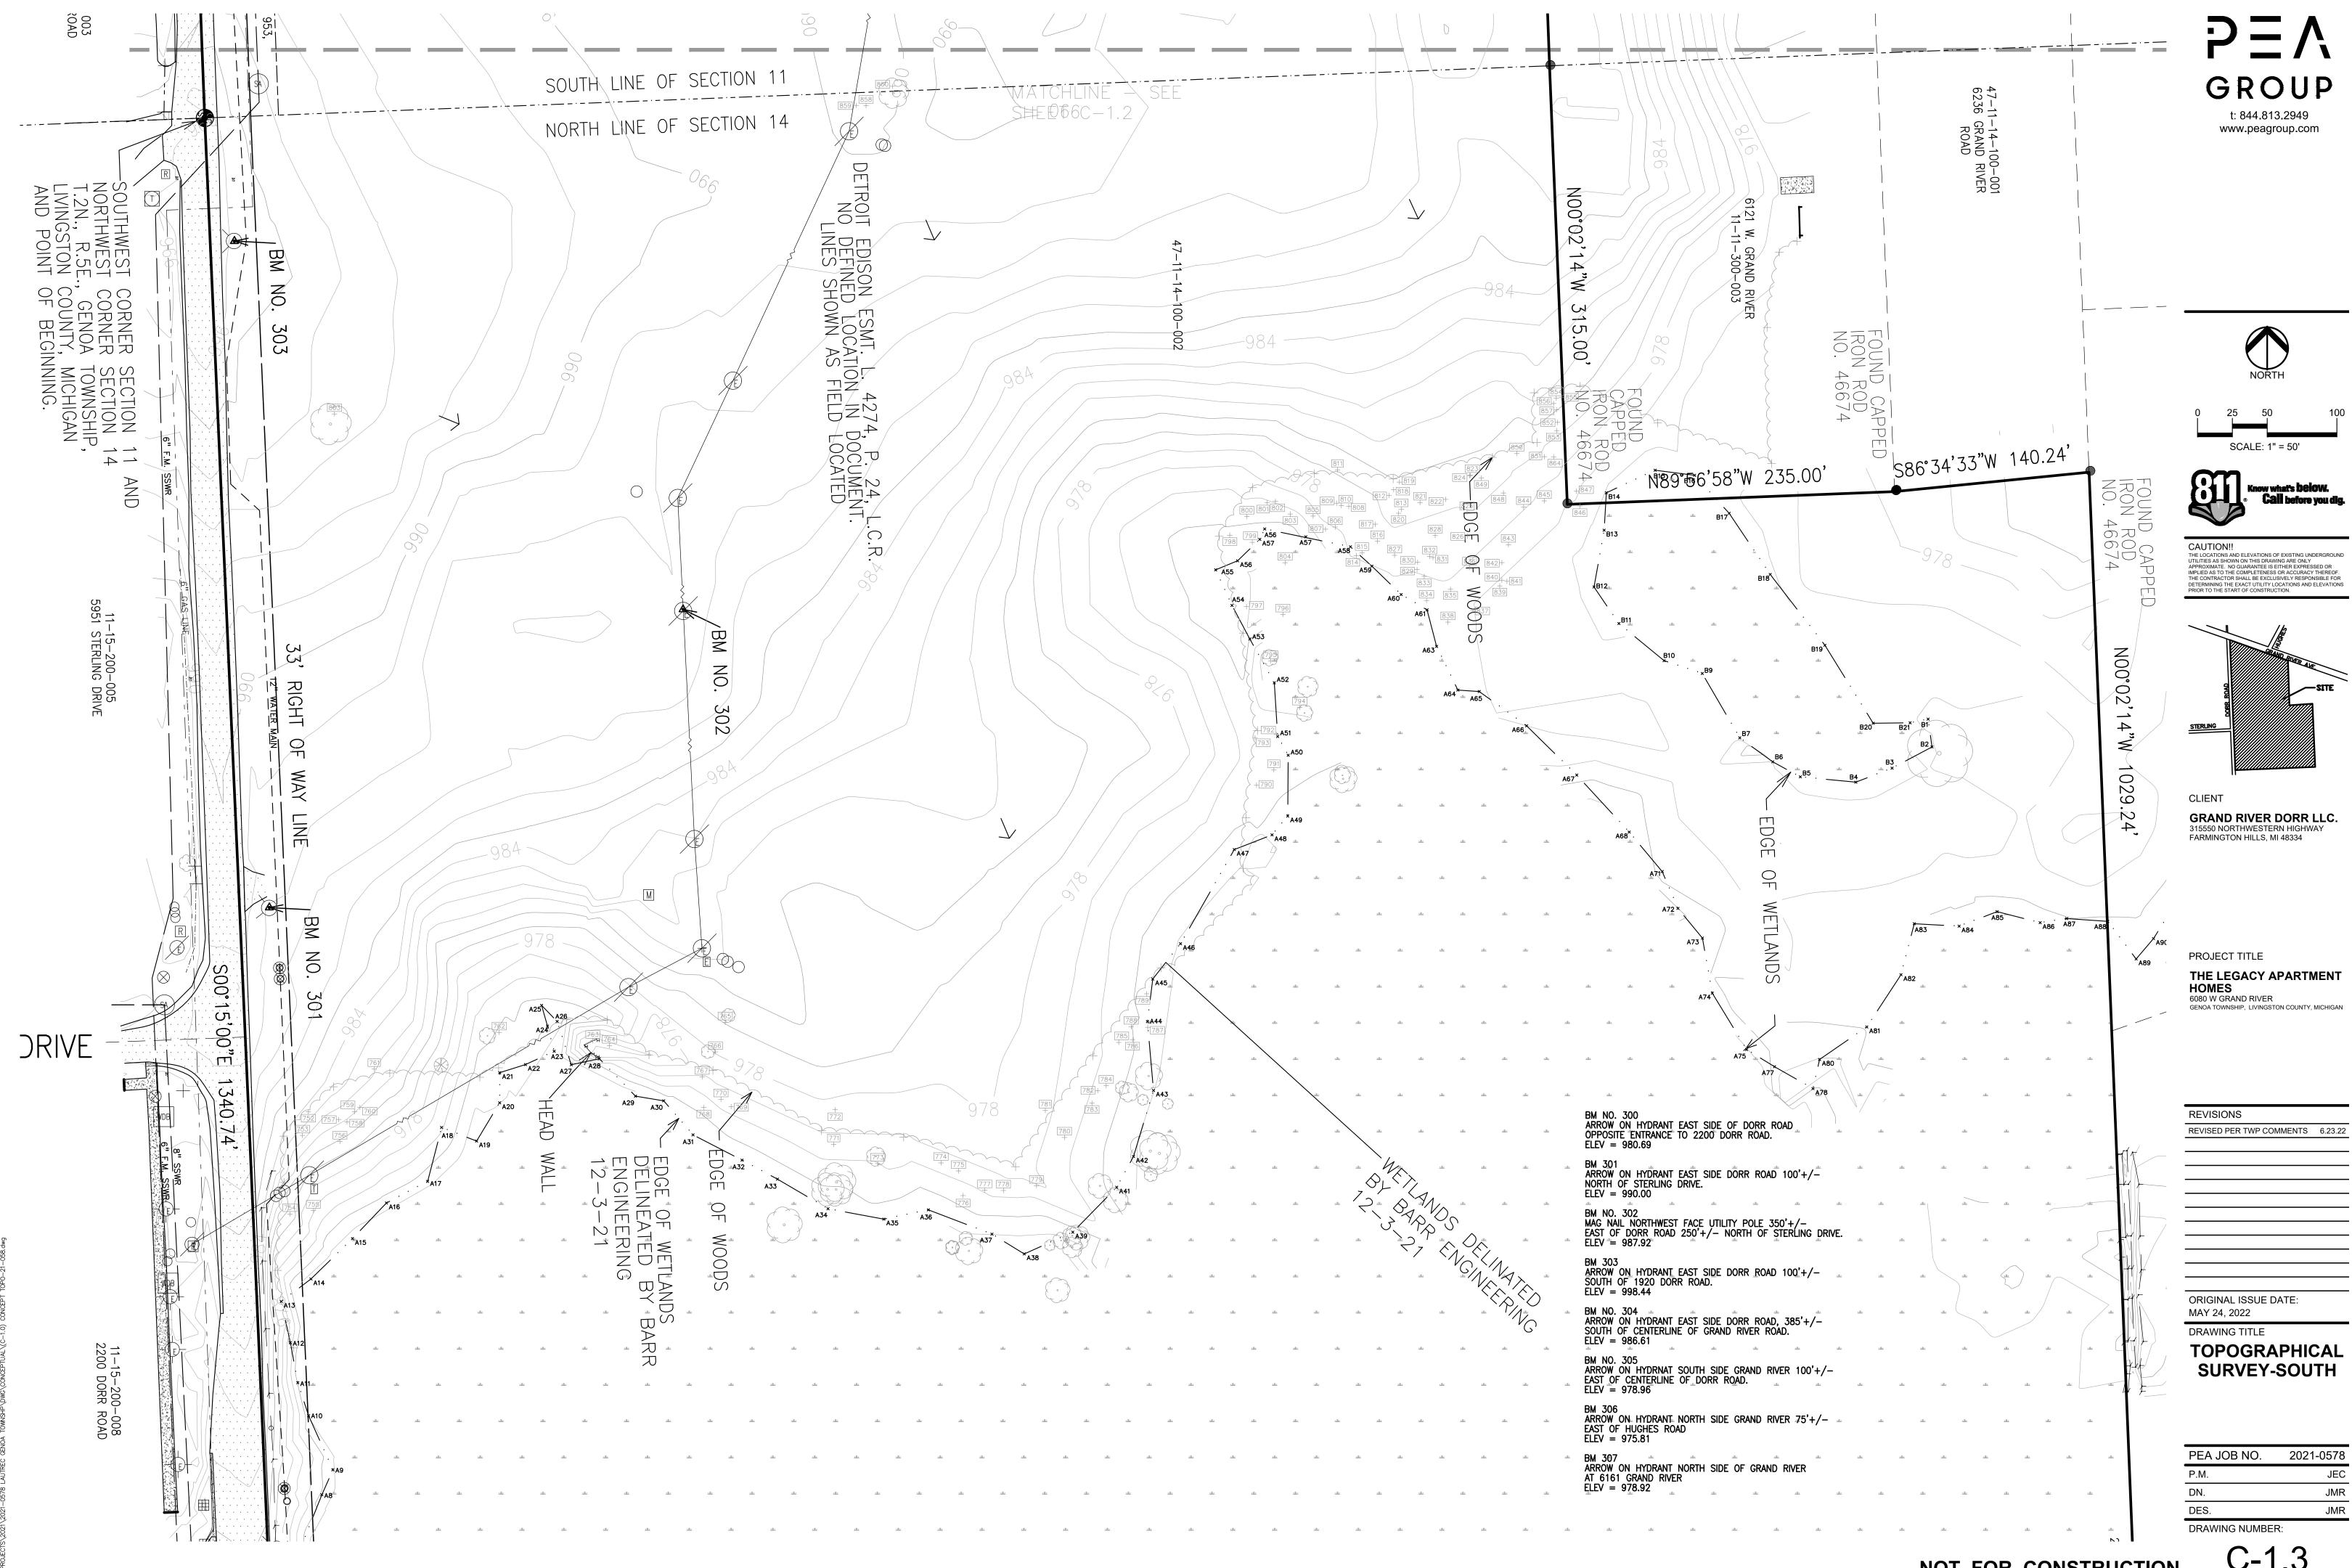


NOT FOR CONSTRUCTION

TAG NO.	CODE	DBH	COMMON NAME	LATIN NAME	COND	COMMENTS
752	RO	10	Red Oak	Quercus rubra	Good	
753	RO	11	Red Oak	Quercus rubra	Good	
754	PN	18	Pin Cherry	Prunus pennsylvanica	Good	
755	RO	13	Red Oak	Quercus rubra	Good	
756	RO	10	Red Oak	Quercus rubra	Good	
757	RO	10	Red Oak	Quercus rubra	Good	x1
758	RO	9	Red Oak	Quercus rubra	Good	
759	RO	11	Red Oak	Quercus rubra	Good	
760	RO	8	Red Oak	Quercus rubra	Good	x1
761	RO	10	Red Oak	Quercus rubra	Good	
762	ВХ	21	Box elder	Acer negundo	Fair	x1
763	AP	10	Domestic Apple	Malus sylvestris	Fair	x1
764	ВС	10	Wild Black Cherry	Prunus serotina	Poor	
765	BG	10	Bigtooth Aspen	Populus grandidentata	Good	
766	E	10	American Elm	Ulmus americana	Good	
767	AP	9	Domestic Apple	Malus sylvestris	Fair	
768	ВС	10	Wild Black Cherry	Prunus serotina	Fair	
769	MW	12	White Mulberry	Morus alba	Fair	
770	ВС	13	Wild Black Cherry	Prunus serotina	Fair	
771	BC	13	Wild Black Cherry	Prunus serotina	Fair	
772	BC	9	Wild Black Cherry	Prunus serotina	Fair	
773	BC	15	Wild Black Cherry	Prunus serotina	Fair	
774	AP	12	Domestic Apple	Malus sylvestris	Fair	
775	AP	8	Domestic Apple	Malus sylvestris	Fair	
776	AP	8	Domestic Apple	Malus sylvestris	Fair	x1
777	AP	8	Domestic Apple	Malus sylvestris	Fair	
778	RO	9	Red Oak	Quercus rubra	Good	
779	AP	10	Domestic Apple	Malus sylvestris	Fair	
780	AP	12	Domestic Apple	Malus sylvestris	Fair	
781	RO	12	Red Oak	Quercus rubra	Good	
782	AP	11	Domestic Apple	Malus sylvestris	Fair	
783	AP	10	Domestic Apple	Malus sylvestris	Fair	
784	AP	8	Domestic Apple	Malus sylvestris	Fair	x1
785	BG	8	Bigtooth Aspen	Populus grandidentata	Fair	
786	BG	10	Bigtooth Aspen	Populus grandidentata	Very Poor	
787	BG	9	Bigtooth Aspen	Populus grandidentata	Fair	
788	BG	10	Bigtooth Aspen	Populus grandidentata	Fair	
789	BG	10	Bigtooth Aspen	Populus grandidentata	Very Poor	
790	AP	8	Domestic Apple	Malus sylvestris	Fair	
791	AP	8	Domestic Apple	Malus sylvestris	Fair	x5
791	BG	9	Bigtooth Aspen	Populus grandidentata	Good	۸5
792	RO	12	Red Oak	Quercus rubra	Fair	
794	SWO	14	Swamp White Oak	Quercus bicolor	Fair	
79 4 795	SWO	14	Swamp White Oak	Quercus bicolor	Fair	
795 796	SWO	16	Swamp White Oak	Quercus bicolor	Fair	
790	BX	11	Box elder	Acer negundo	Poor	x1
797	AP	18	Domestic Apple	Malus sylvestris	Fair	x1 x5
798 799	BG	11	Bigtooth Aspen	·		χυ
800			•	Populus grandidentata Prunus serotina	Dead Fair	
800	BC BC	9 16	Wild Black Cherry			
			Wild Black Cherry	Prunus serotina	Poor	
802	BC	14	Wild Black Cherry	Prunus serotina	Fair	<u></u>
803	BC	16	Wild Black Cherry	Prunus serotina	Fair	<u>x1</u>
804	GA	8	Green Ash	Fraxinus pennsylvanica	Poor	x1
805	BC	18	Wild Black Cherry	Prunus serotina	Fair	
806	BC	9	Wild Black Cherry	Prunus serotina	Fair	
807	BC	9	Wild Black Cherry	Prunus serotina	Fair	
808	ВС	14	Wild Black Cherry	Prunus serotina	Poor	x1

TAG NO.	CODE	DBH	COMMON NAME	LATIN NAME	COND	COMMENTS
809	ВС	13	Wild Black Cherry	Prunus serotina	Fair	
810	ВС	11	Wild Black Cherry	Prunus serotina	Poor	
811	ВС	12	Wild Black Cherry	Prunus serotina	Fair	
812	ВС	16	Wild Black Cherry	Prunus serotina	Fair	x1
813	ВС	13	Wild Black Cherry	Prunus serotina	Fair	
814	ВС	8	Wild Black Cherry	Prunus serotina	Poor	
815	ВС	9	Wild Black Cherry	Prunus serotina	Fair	
816	PN	11	Pin Cherry	Prunus pennsylvanica	Fair	check YB
817	PN	12	Pin Cherry	Prunus pennsylvanica	Fair	
818	ВС	9	Wild Black Cherry	Prunus serotina	Fair	
819	BX	12	Box elder	Acer negundo	Fair	
820	ВС	13	Wild Black Cherry	Prunus serotina	Fair	
821	ВС	11	Wild Black Cherry	Prunus serotina	Fair	
822	PN	14	Pin Cherry	Prunus pennsylvanica	Good	
823	BX	17	Box elder	Acer negundo	Fair	x1
824	ВХ	8	Box elder	Acer negundo	Fair	
825	ВХ	10	Box elder	Acer negundo	Fair	
826	ВХ	8	Box elder	Acer negundo	Fair	
827	SM	21	Silver Maple	Acer saccharinum	Good	x1
828	ВС	10	Wild Black Cherry	Prunus serotina	Poor	
829	ВС	11	Wild Black Cherry	Prunus serotina	Very Poor	crown broke off
830	BC	8	Wild Black Cherry	Prunus serotina	Poor	
831	BC	9	Wild Black Cherry	Prunus serotina	Fair	
832	BC	8	Wild Black Cherry	Prunus serotina	Poor	
833	BC	12	Wild Black Cherry	Prunus serotina	Fair	
834	BC	9	Wild Black Cherry	Prunus serotina	Poor	
835	BX	8	Box elder	Acer negundo	Very Poor	x1
836	BX	10	Box elder	Acer negundo	Fair	X 1
837	PN	11	Pin Cherry	Prunus pennsylvanica	Fair	
838	BC	12	Wild Black Cherry	Prunus serotina	Fair	
839	RO	18	Red Oak	Quercus rubra	Fair	
840	YB	13	Yellow Birch	Betula alleghaniensis	Fair	
841	BX	8	Box elder	Acer negundo	Poor	
842	BC	8	Wild Black Cherry	Prunus serotina	Fair	
843	BX	8	Box elder	Acer negundo	Very Poor	
844	BC	16	Wild Black Cherry	Prunus serotina	Fair	
845	BX	8	Box elder	Acer negundo	Poor	
846	ВС	27	Wild Black Cherry	Prunus serotina	Fair	x1
847	BC	14	Wild Black Cherry	Prunus serotina	Fair	
848	BX	9	Box elder	Acer negundo	Fair	
849	ВХ	9	Box elder	Acer negundo	Very Poor	
850	ВХ	8	Box elder	Acer negundo	Fair	x1
851	ВО	16	Black Oak	Quercus velutina	Good	x1
852	BX	9	Box elder	Acer negundo	Poor	х3
853	BX	9	Box elder	Acer negundo	Fair	
854	ВС	11	Wild Black Cherry	Prunus serotina	Fair	
855	RO	13	Red Oak	Quercus rubra	Fair	
856	ВС	13	Wild Black Cherry	Prunus serotina	Fair	
857	RO	11	Red Oak	Quercus rubra	Fair	
858	ВС	8	Wild Black Cherry	Prunus serotina	Fair	х3
859	ВС	8	Wild Black Cherry	Prunus serotina	Fair	
860	RO	17	Red Oak	Quercus rubra	Good	x1
861	AP	17	Domestic Apple	Malus sylvestris	Poor	x2
862	AP	25	Domestic Apple	Malus sylvestris	Poor	
863	WO	38	White Oak	Quercus alba	Very Poor	
864	ВС	13	Wild Black Cherry	Prunus serotina	Fair	






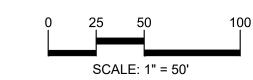



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CLIENT GRAND RIVER DORR LLC. 315550 NORTHWESTERN HIGHWAY FARMINGTON HILLS, MI 48334

PROJECT TITLE

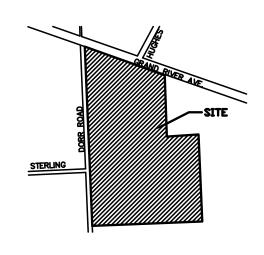THE LEGACY APARTMENT HOMES
6080 W GRAND RIVER
GENOA TOWNSHIP, LIVINGSTON COUNTY, MICHIGAN


REVISIONS REVISED PER TWP COMMENTS 6.23.22

ORIGINAL ISSUE DATE: MAY 24, 2022


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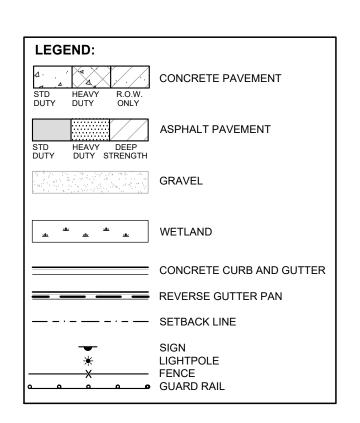
TREE LIST

PEA JOB NO.	2021-0578			
P.M.	JEC			
DN.	JMR			
DES.	JMR			
DRAWING NUMBER:				

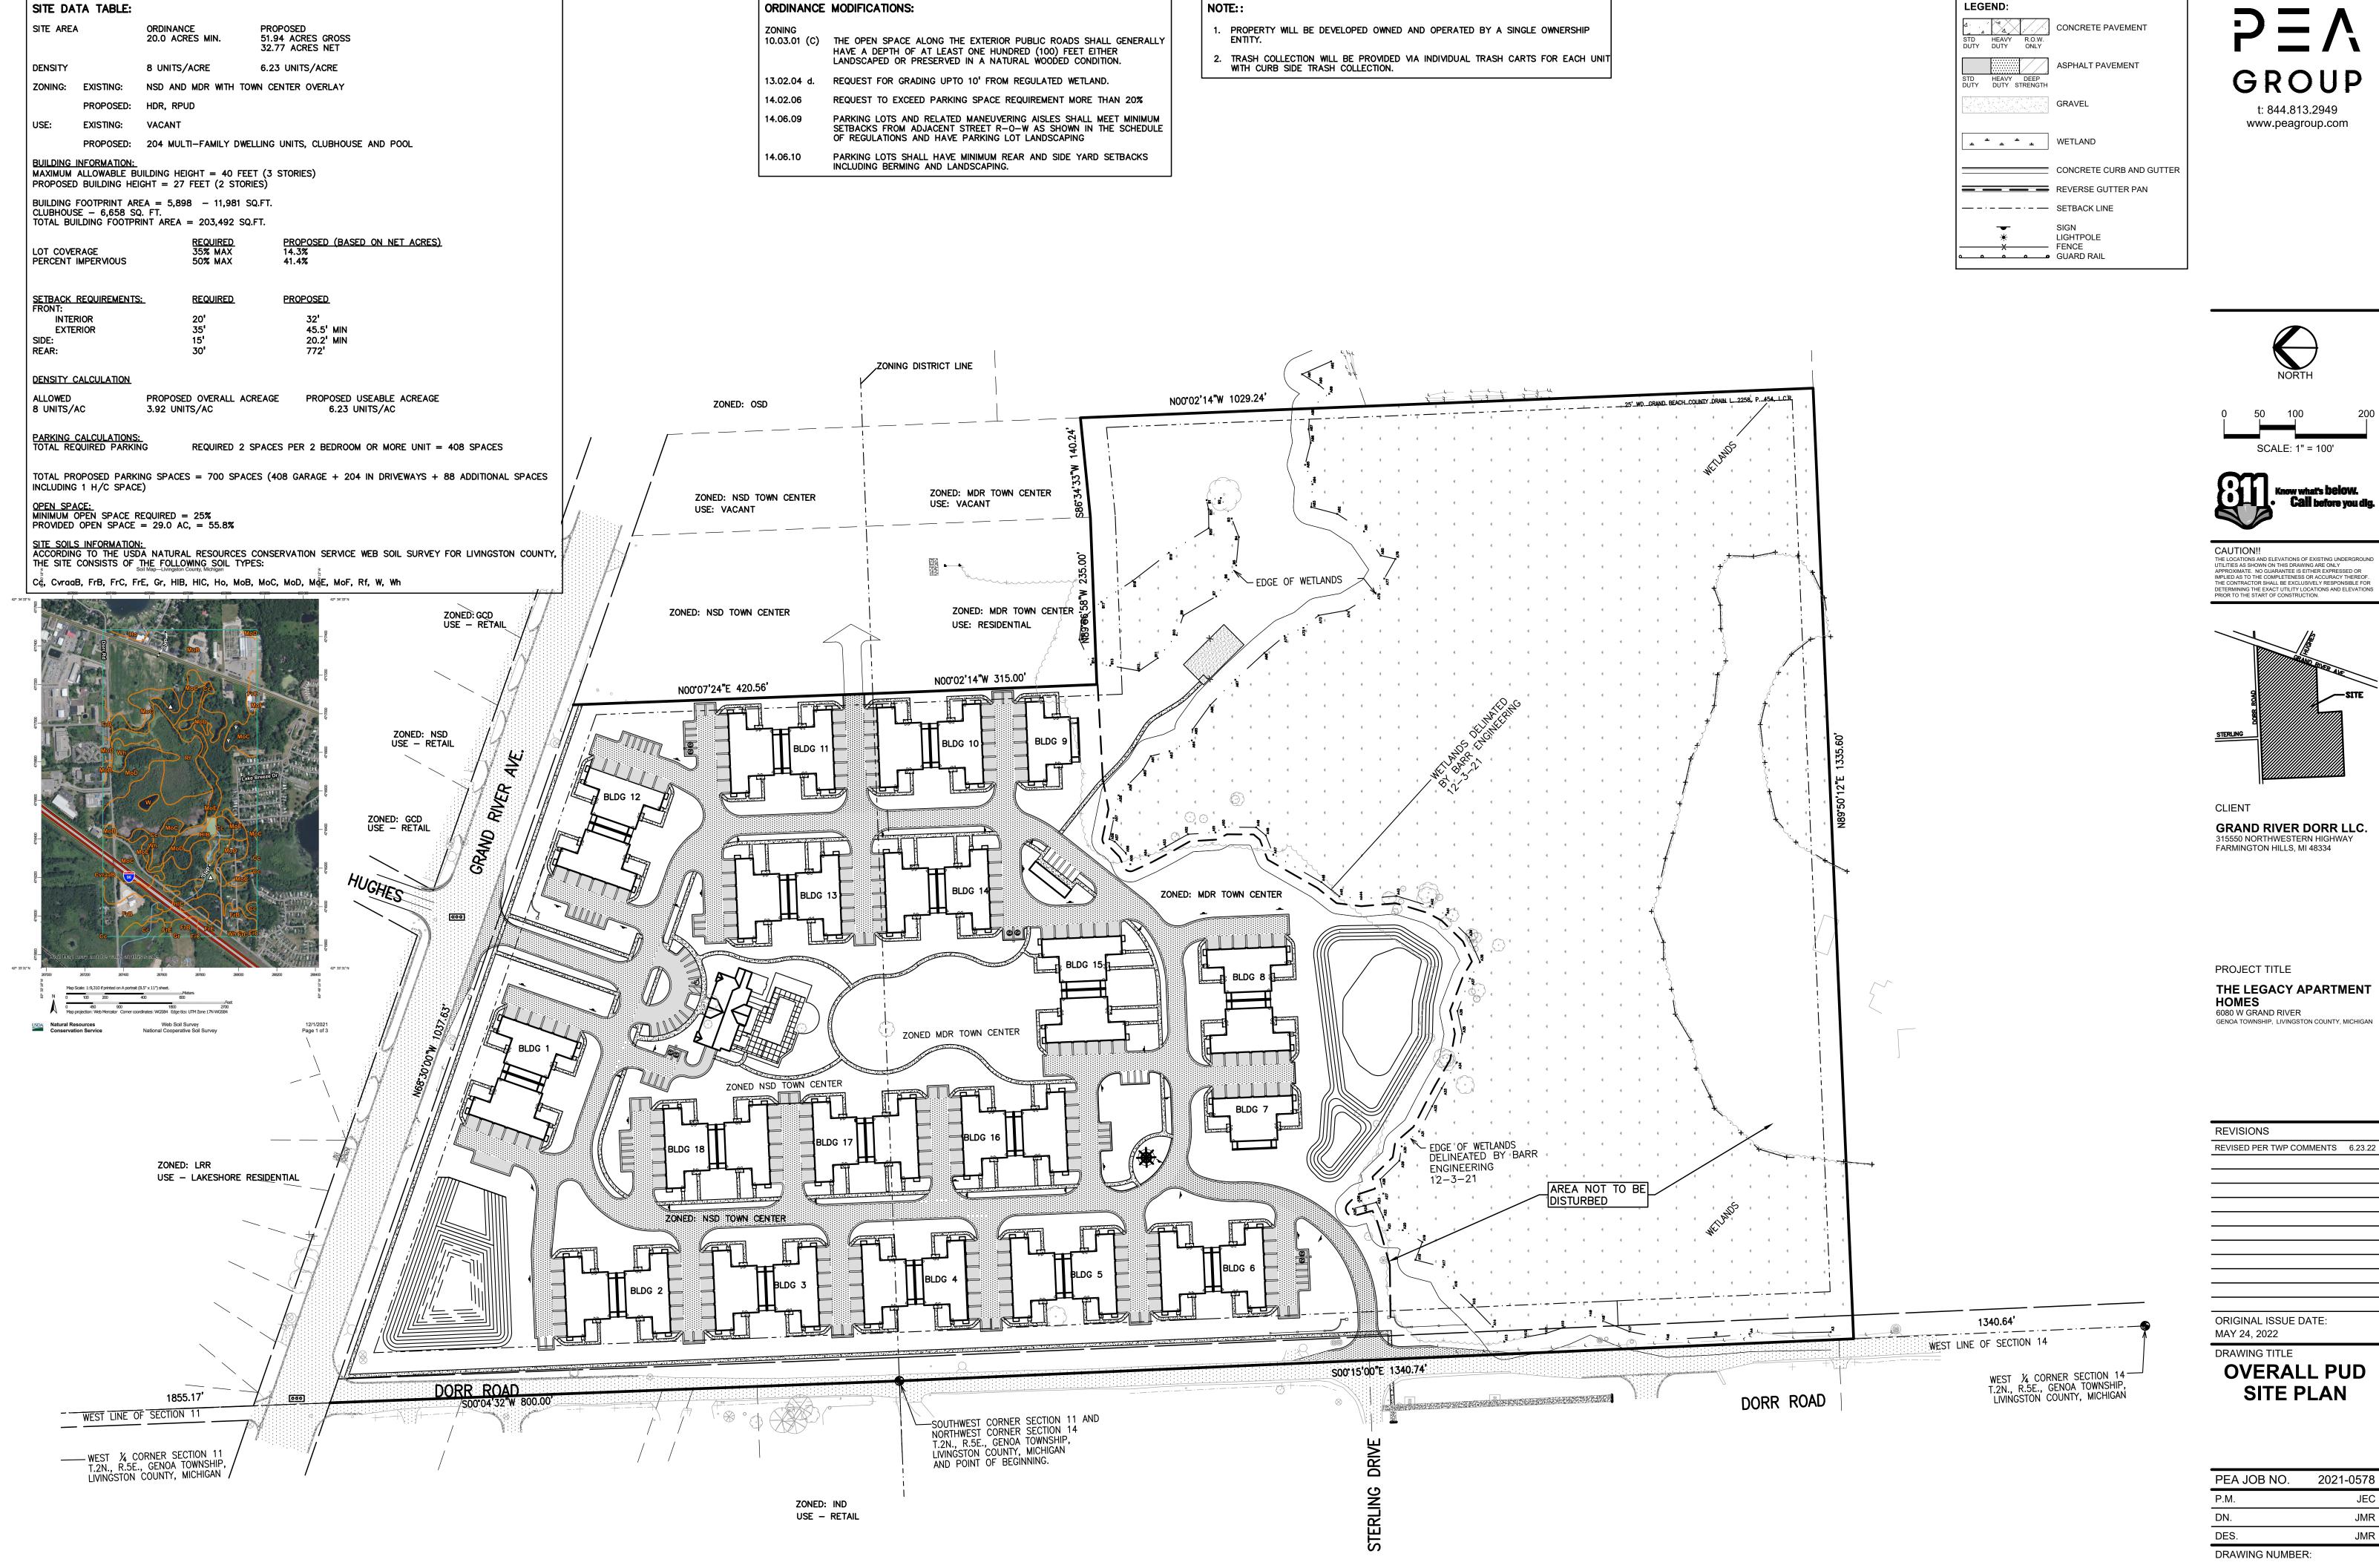

C-2.1



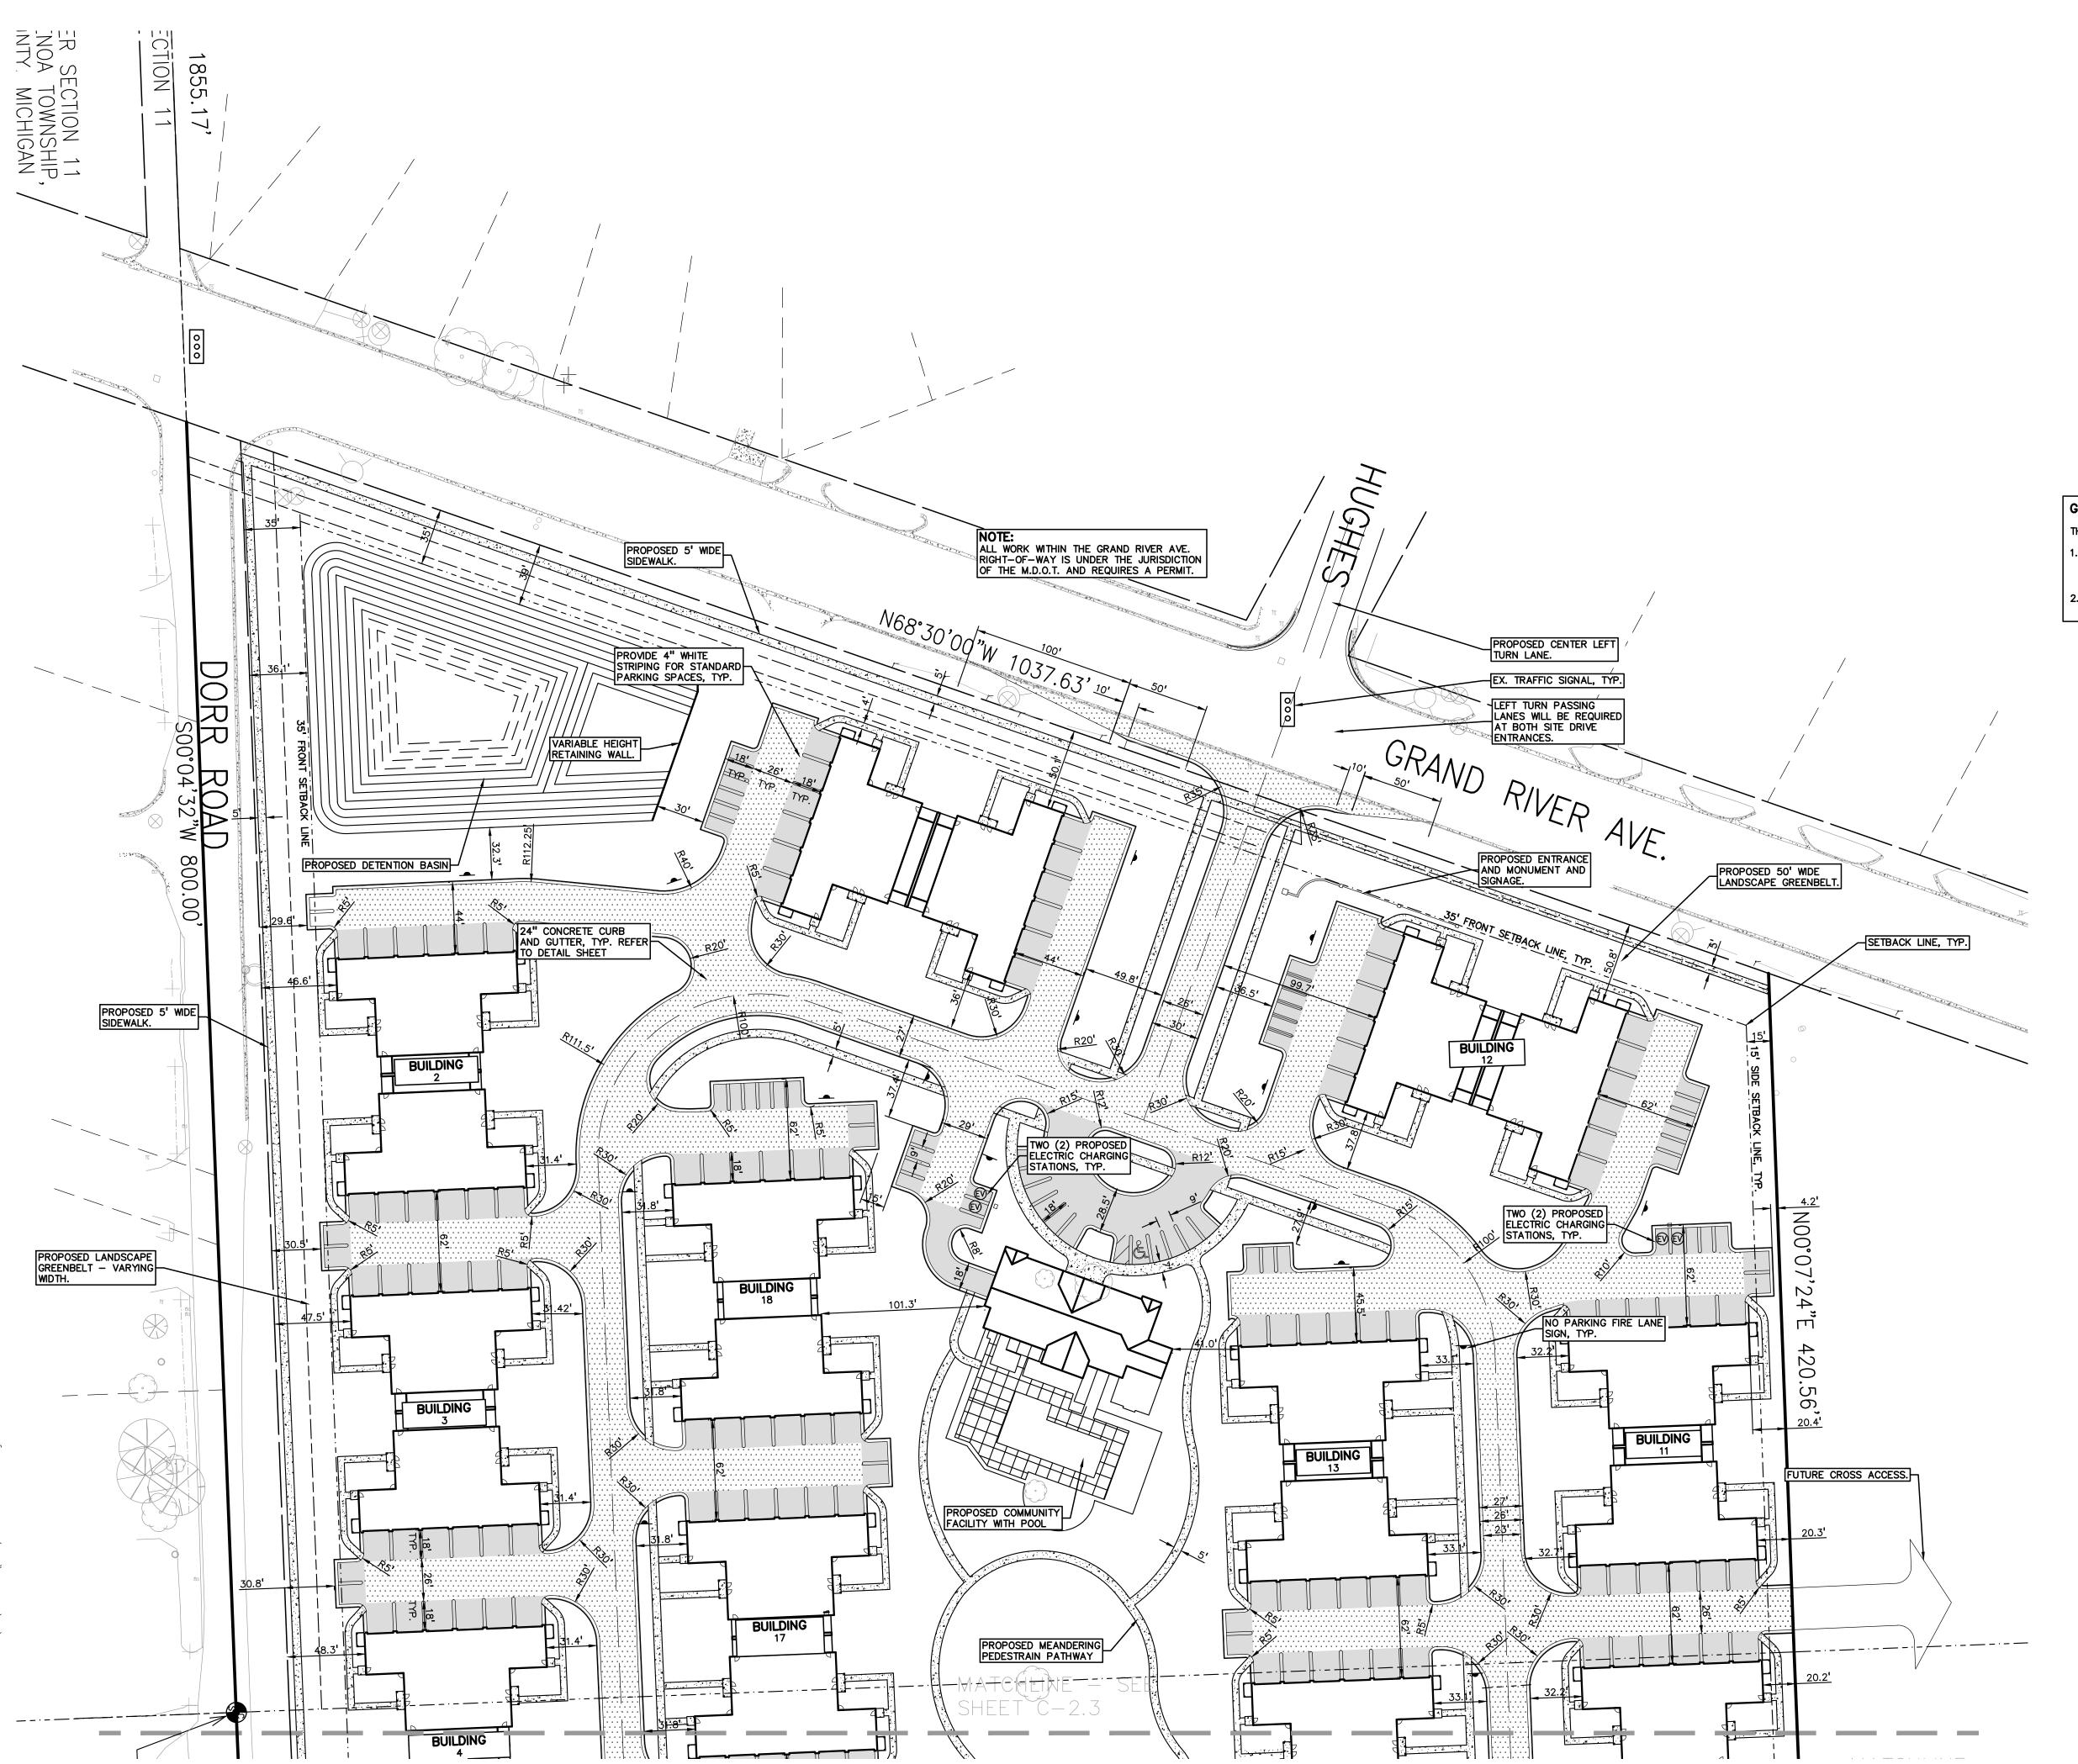





SCALE: 1" = 50'


GENERAL NOTES:

THESE NOTES APPLY TO ALL CONSTRUCTION ACTIVITIES ON THIS PROJECT.

- 1. ALL DIMENSIONS SHOWN ARE TO FACE OF CURB, FACE OF SIDEWALK, OUTSIDE FACE OF BUILDING, PROPERTY LINE, CENTER OF MANHOLE/CATCH BASIN OR CENTERLINE OF PIPE UNLESS OTHERWISE NOTED.
- 2. 'NO PARKING-FIRE LANE' SIGNS SHALL BE POSTED ALONG ALL FIRE LANES AT 50'-100' FOOT INTERVALS OR AS DIRECTED BY THE FIRE OFFICIAL.





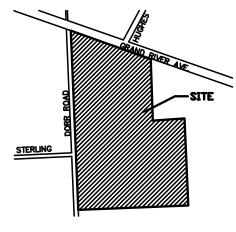

CLIENT

GRAND RIVER DORR LLC.
315550 NORTHWESTERN HIGHWAY
FARMINGTON HILLS, MI 48334

PROJECT TITLE

THE LEGACY APARTMENT HOMES
6080 W GRAND RIVER
GENOA TOWNSHIP, LIVINGSTON COUNTY, MICHIGAN

REVISIONS

REVISED PER TWP COMMENTS 6.23.22

ORIGINAL ISSUE DATE: MAY 24, 2022

CONCEPTUAL
PUD SITE
PLAN-NORTH


PEA JOB NO. 2021-0578

P.M. JEC


DN. JMR

DES. JMR

DRAWING NUMBER:

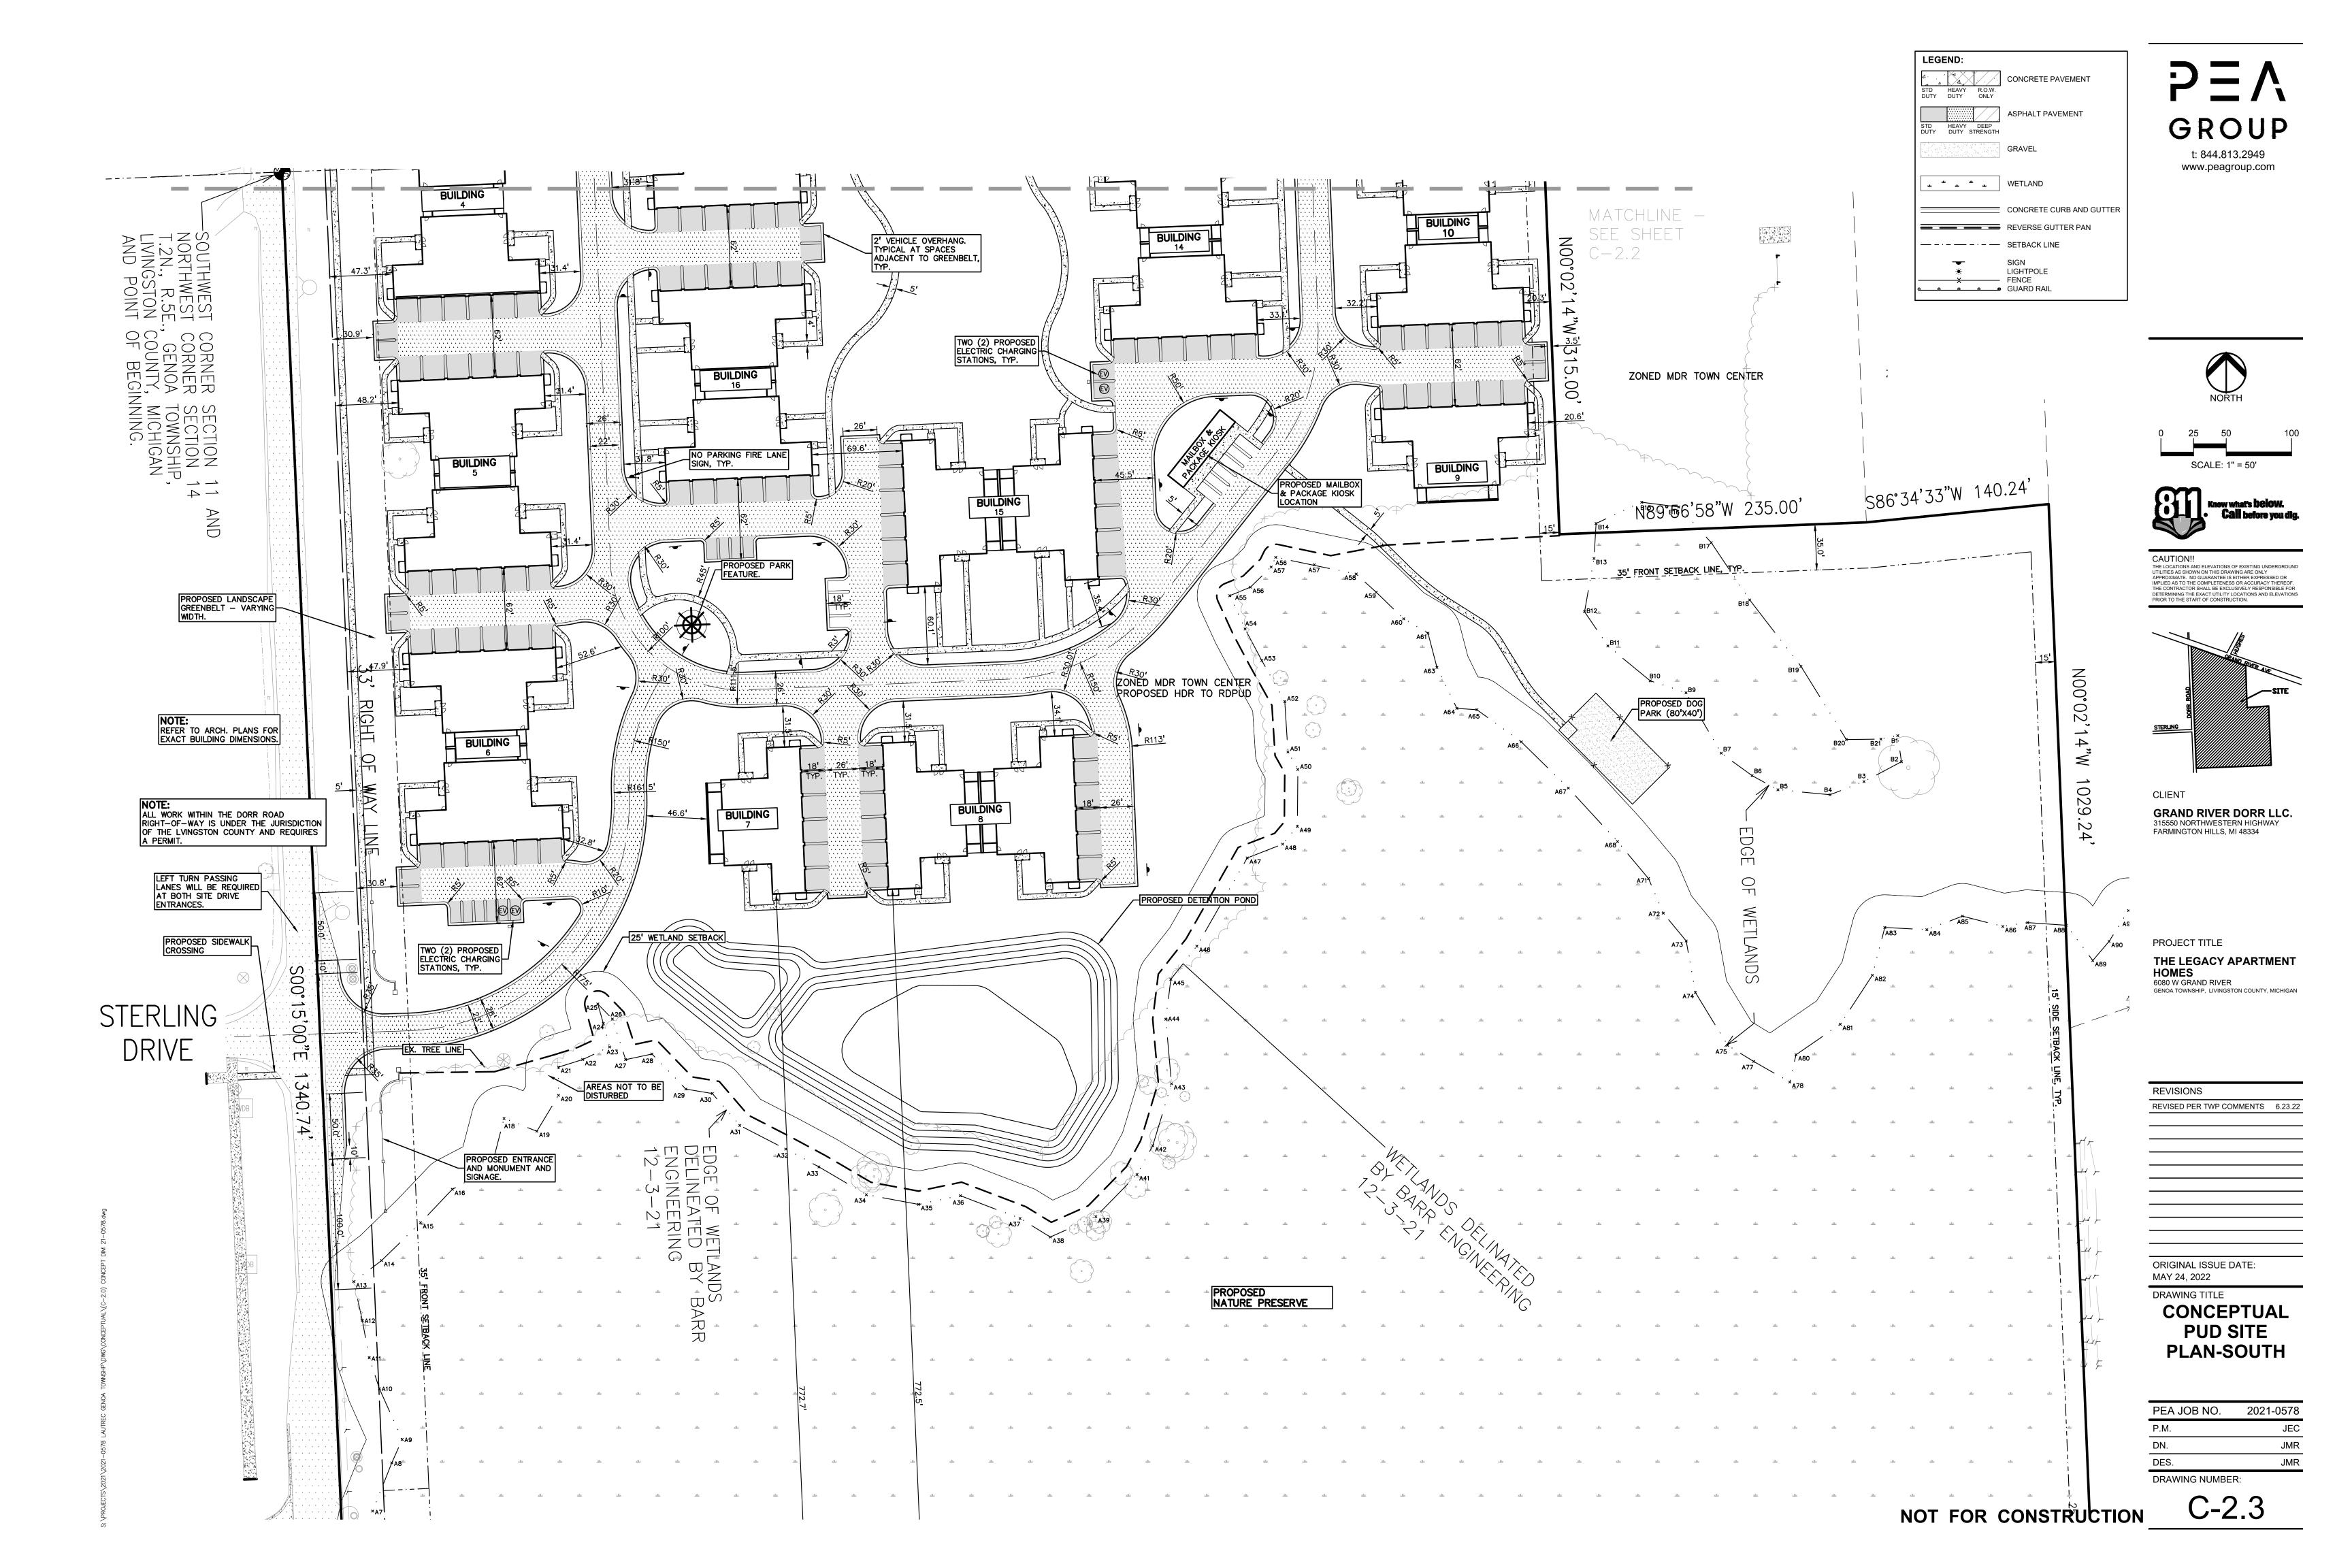




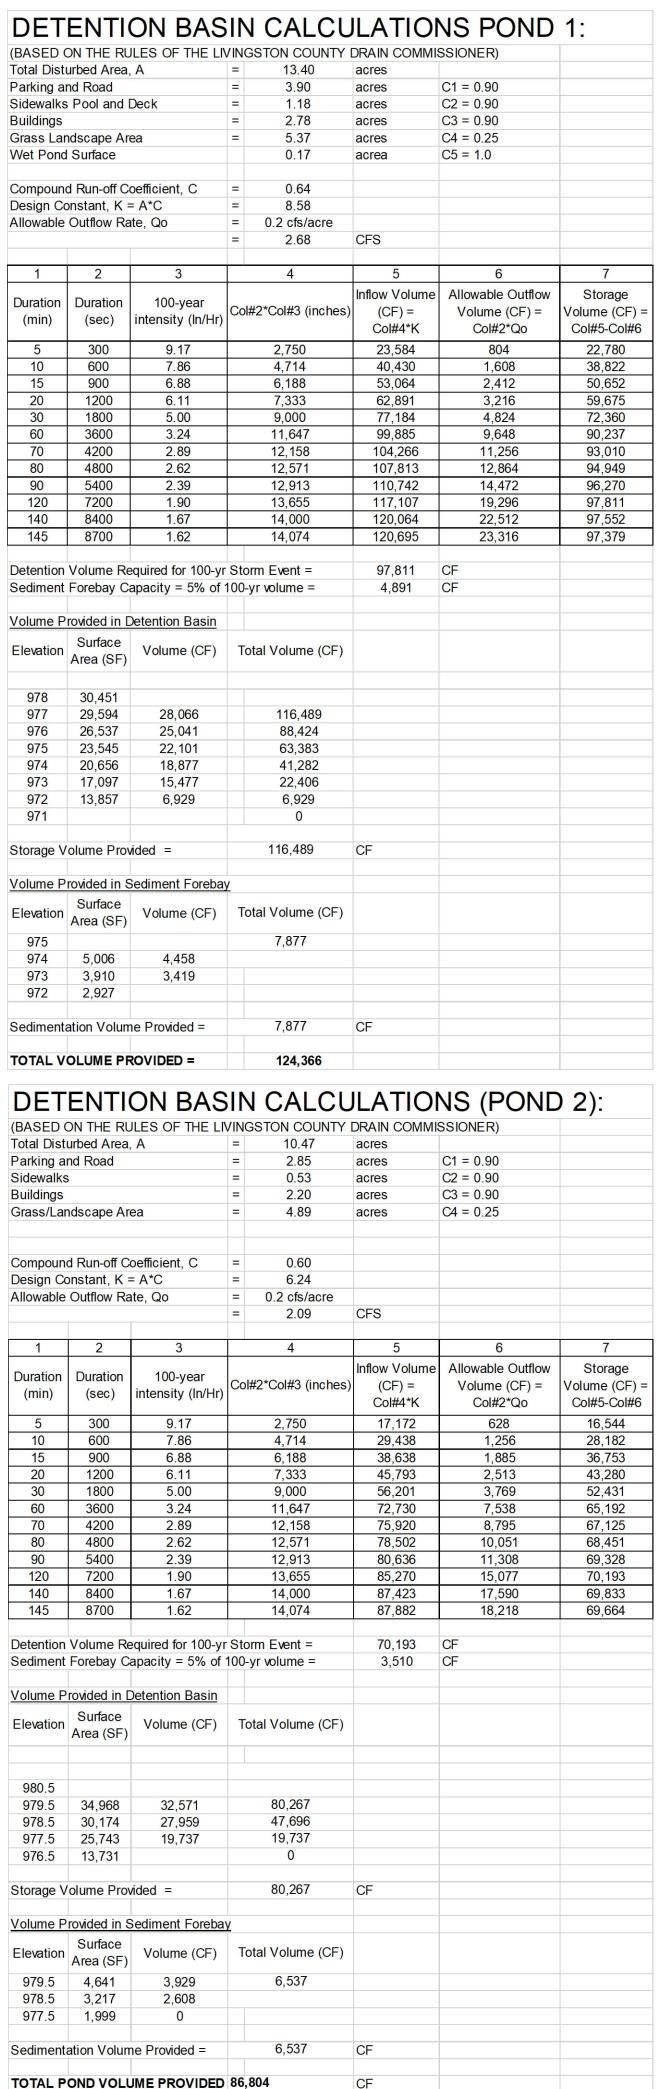






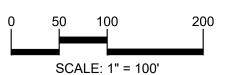



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IMPLIED AS TO THE COMPLETENESS OR ACCURACY THEREOF.
THE CONTRACTOR SHALL BE EXCLUSIVELY RESPONSIBLE FOR
DETERMINING THE EXACT UTILITY LOCATIONS AND ELEVATIONS
PRIOR TO THE START OF CONSTRUCTION.

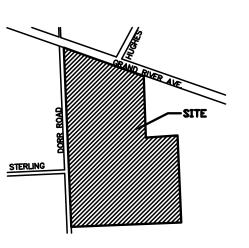

CLIENT

GRAND RIVER DORR LLC. 315550 NORTHWESTERN HIGHWAY FARMINGTON HILLS, MI 48334

PROJECT TITLE


THE LEGACY APARTMENT HOMES
6080 W GRAND RIVER
GENOA TOWNSHIP, LIVINGSTON COUNTY, MICHIGAN

REVISIONS
REVISED PER TWP COMMENTS 6.23.22

ORIGINAL ISSUE DATE:

CONCEPTUAL
STORM WATER
MANAGEMENT
PLAN

F	PEA JOB NO.	2021-0578
F	P.M.	JEC
	N.	JMR
	ES.	JMR
	RAWING NUMBER:	

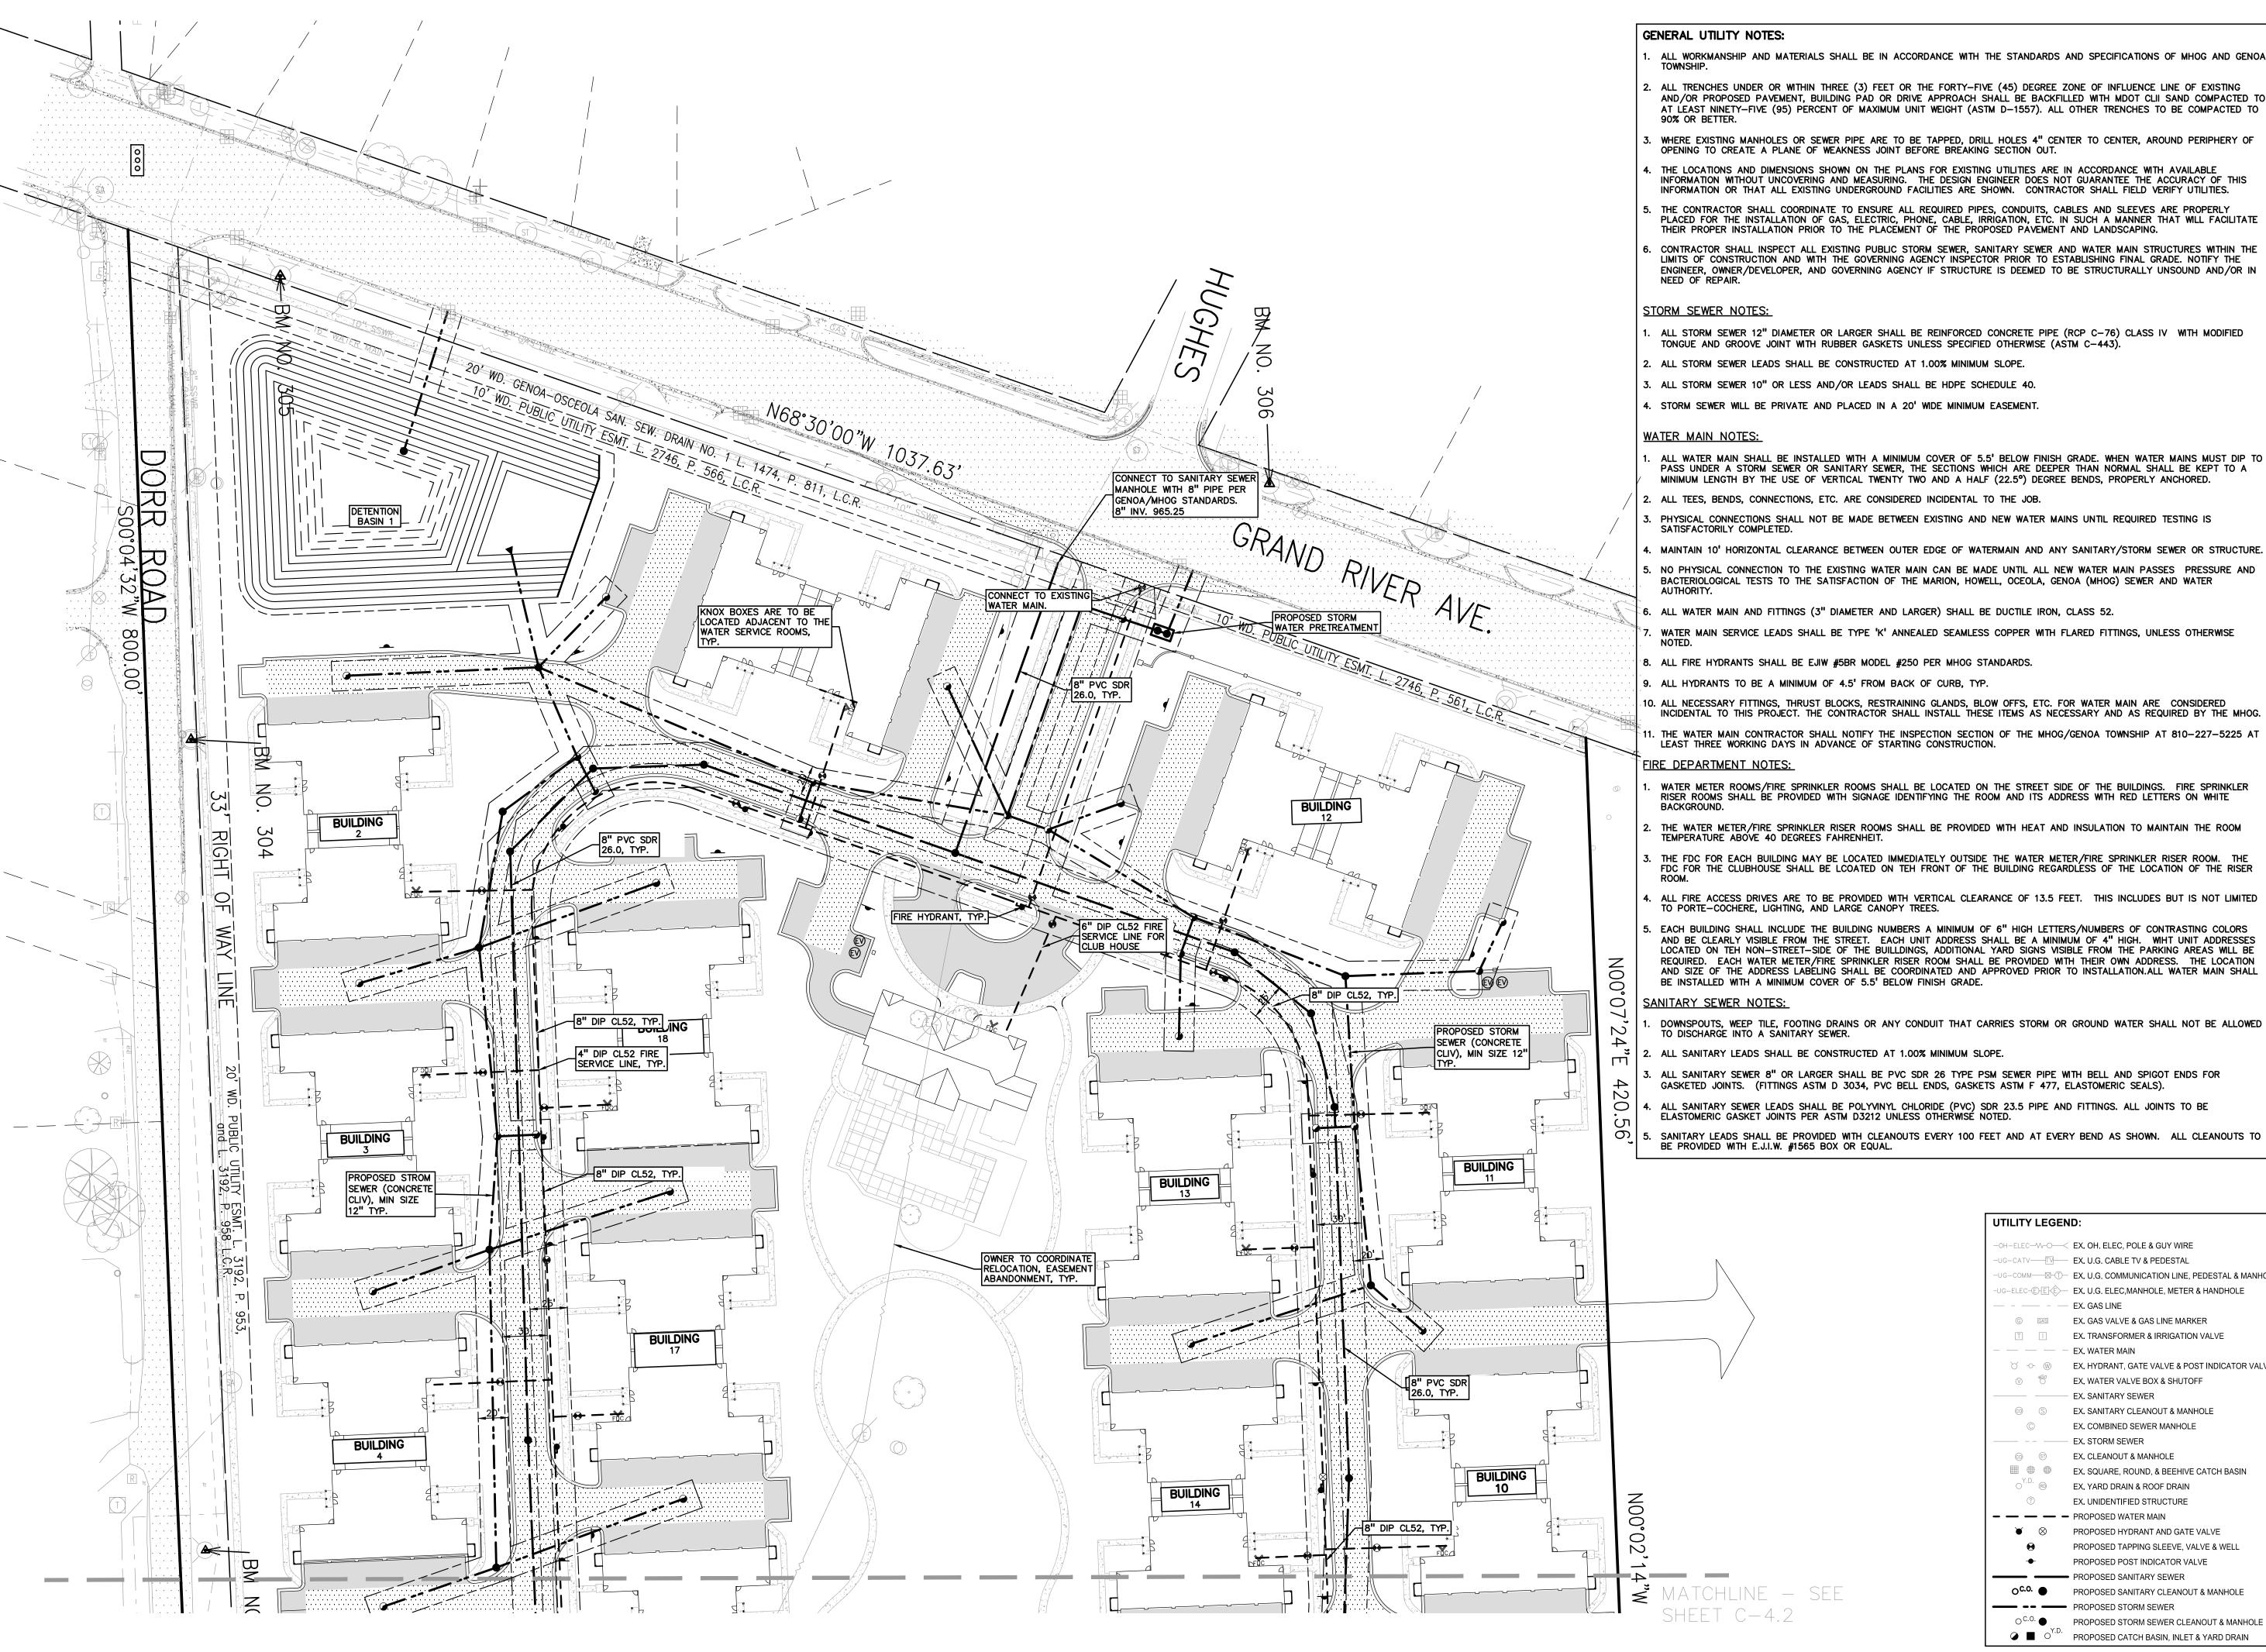

- ALL WORKMANSHIP AND MATERIALS SHALL BE IN ACCORDANCE WITH THE STANDARDS AND SPECIFICATIONS OF MHOG AND GENOA
- 2. ALL TRENCHES UNDER OR WITHIN THREE (3) FEET OR THE FORTY-FIVE (45) DEGREE ZONE OF INFLUENCE LINE OF EXISTING AND/OR PROPOSED PAVEMENT, BUILDING PAD OR DRIVE APPROACH SHALL BE BACKFILLED WITH MDOT CLII SAND COMPACTED TO AT LEAST NINETY-FIVE (95) PERCENT OF MAXIMUM UNIT WEIGHT (ASTM D-1557). ALL OTHER TRENCHES TO BE COMPACTED TO
- WHERE EXISTING MANHOLES OR SEWER PIPE ARE TO BE TAPPED, DRILL HOLES 4" CENTER TO CENTER, AROUND PERIPHERY OF OPENING TO CREATE A PLANE OF WEAKNESS JOINT BEFORE BREAKING SECTION OUT.
- THE LOCATIONS AND DIMENSIONS SHOWN ON THE PLANS FOR EXISTING UTILITIES ARE IN ACCORDANCE WITH AVAILABLE INFORMATION WITHOUT UNCOVERING AND MEASURING. THE DESIGN ENGINEER DOES NOT GUARANTEE THE ACCURACY OF THIS
- THE CONTRACTOR SHALL COORDINATE TO ENSURE ALL REQUIRED PIPES, CONDUITS, CABLES AND SLEEVES ARE PROPERLY PLACED FOR THE INSTALLATION OF GAS, ELECTRIC, PHONE, CABLE, IRRIGATION, ETC. IN SUCH A MANNER THAT WILL FACILITATE THEIR PROPER INSTALLATION PRIOR TO THE PLACEMENT OF THE PROPOSED PAVEMENT AND LANDSCAPING.
- CONTRACTOR SHALL INSPECT ALL EXISTING PUBLIC STORM SEWER, SANITARY SEWER AND WATER MAIN STRUCTURES WITHIN THE LIMITS OF CONSTRUCTION AND WITH THE GOVERNING AGENCY INSPECTOR PRIOR TO ESTABLISHING FINAL GRADE. NOTIFY THE ENGINEER, OWNER/DEVELOPER, AND GOVERNING AGENCY IF STRUCTURE IS DEEMED TO BE STRUCTURALLY UNSOUND AND/OR IN
- ALL STORM SEWER 12" DIAMETER OR LARGER SHALL BE REINFORCED CONCRETE PIPE (RCP C-76) CLASS IV WITH MODIFIED TONGUE AND GROOVE JOINT WITH RUBBER GASKETS UNLESS SPECIFIED OTHERWISE (ASTM C-443).

- 4. STORM SEWER WILL BE PRIVATE AND PLACED IN A 20' WIDE MINIMUM EASEMENT.
- ALL WATER MAIN SHALL BE INSTALLED WITH A MINIMUM COVER OF 5.5' BELOW FINISH GRADE. WHEN WATER MAINS MUST DIP TO PASS UNDER A STORM SEWER OR SANITARY SEWER, THE SECTIONS WHICH ARE DEEPER THAN NORMAL SHALL BE KEPT TO A MINIMUM LENGTH BY THE USE OF VERTICAL TWENTY TWO AND A HALF (22.5°) DEGREE BENDS, PROPERLY ANCHORED.
- 2. ALL TEES, BENDS, CONNECTIONS, ETC. ARE CONSIDERED INCIDENTAL TO THE JOB.
- PHYSICAL CONNECTIONS SHALL NOT BE MADE BETWEEN EXISTING AND NEW WATER MAINS UNTIL REQUIRED TESTING IS
- MAINTAIN 10' HORIZONTAL CLEARANCE BETWEEN OUTER EDGE OF WATERMAIN AND ANY SANITARY/STORM SEWER OR STRUCTURE. NO PHYSICAL CONNECTION TO THE EXISTING WATER MAIN CAN BE MADE UNTIL ALL NEW WATER MAIN PASSES PRESSURE AND BACTERIOLOGICAL TESTS TO THE SATISFACTION OF THE MARION, HOWELL, OCEOLA, GENOA (MHOG) SEWER AND WATER
- ALL WATER MAIN AND FITTINGS (3" DIAMETER AND LARGER) SHALL BE DUCTILE IRON, CLASS 52.
- WATER MAIN SERVICE LEADS SHALL BE TYPE 'K' ANNEALED SEAMLESS COPPER WITH FLARED FITTINGS, UNLESS OTHERWISE
- 8. ALL FIRE HYDRANTS SHALL BE EJIW #5BR MODEL #250 PER MHOG STANDARDS.
- 9. ALL HYDRANTS TO BE A MINIMUM OF 4.5' FROM BACK OF CURB, TYP.
- IO. ALL NECESSARY FITTINGS, THRUST BLOCKS, RESTRAINING GLANDS, BLOW OFFS, ETC. FOR WATER MAIN ARE CONSIDERED INCIDENTAL TO THIS PROJECT. THE CONTRACTOR SHALL INSTALL THESE ITEMS AS NECESSARY AND AS REQUIRED BY THE MHOG.
- . THE WATER MAIN CONTRACTOR SHALL NOTIFY THE INSPECTION SECTION OF THE MHOG/GENOA TOWNSHIP AT 810-227-5225 AT LEAST THREE WORKING DAYS IN ADVANCE OF STARTING CONSTRUCTION.
- WATER METER ROOMS/FIRE SPRINKLER ROOMS SHALL BE LOCATED ON THE STREET SIDE OF THE BUILDINGS. FIRE SPRINKLER RISER ROOMS SHALL BE PROVIDED WITH SIGNAGE IDENTIFYING THE ROOM AND ITS ADDRESS WITH RED LETTERS ON WHITE
- THE WATER METER/FIRE SPRINKLER RISER ROOMS SHALL BE PROVIDED WITH HEAT AND INSULATION TO MAINTAIN THE ROOM
- THE FDC FOR EACH BUILDING MAY BE LOCATED IMMEDIATELY OUTSIDE THE WATER METER/FIRE SPRINKLER RISER ROOM. THE FDC FOR THE CLUBHOUSE SHALL BE LCOATED ON TEH FRONT OF THE BUILDING REGARDLESS OF THE LOCATION OF THE RISER
- ALL FIRE ACCESS DRIVES ARE TO BE PROVIDED WITH VERTICAL CLEARANCE OF 13.5 FEET. THIS INCLUDES BUT IS NOT LIMITED TO PORTE-COCHERE, LIGHTING, AND LARGE CANOPY TREES.
- EACH BUILDING SHALL INCLUDE THE BUILDING NUMBERS A MINIMUM OF 6" HIGH LETTERS/NUMBERS OF CONTRASTING COLORS AND BE CLEARLY VISIBLE FROM THE STREET. EACH UNIT ADDRESS SHALL BE A MINIMUM OF 4" HIGH. WHIT UNIT ADDRESSES LOCATED ON TEH NON-STREET-SIDE OF THE BUILLDINGS, ADDITIONAL YARD SIGNS VISIBLE FROM THE PARKING AREAS WILL BE REQUIRED. EACH WATER METER/FIRE SPRINKLER RISER ROOM SHALL BE PROVIDED WITH THEIR OWN ADDRESS. THE LOCATION AND SIZE OF THE ADDRESS LABELING SHALL BE COORDINATED AND APPROVED PRIOR TO INSTALLATION.ALL WATER MAIN SHALL
- DOWNSPOUTS, WEEP TILE, FOOTING DRAINS OR ANY CONDUIT THAT CARRIES STORM OR GROUND WATER SHALL NOT BE ALLOWED
- ALL SANITARY LEADS SHALL BE CONSTRUCTED AT 1.00% MINIMUM SLOPE.
- ALL SANITARY SEWER 8" OR LARGER SHALL BE PVC SDR 26 TYPE PSM SEWER PIPE WITH BELL AND SPIGOT ENDS FOR GASKETED JOINTS. (FITTINGS ASTM D 3034, PVC BELL ENDS, GASKETS ASTM F 477, ELASTOMERIC SEALS).
- ALL SANITARY SEWER LEADS SHALL BE POLYVINYL CHLORIDE (PVC) SDR 23.5 PIPE AND FITTINGS. ALL JOINTS TO BE ELASTOMERIC GASKET JOINTS PER ASTM D3212 UNLESS OTHERWISE NOTED.

UTILITY LEGEND:

OH-ELEC-VV-O- EX. OH. ELEC, POLE & GUY WIRE

UG-CATV-TV- EX. U.G. CABLE TV & PEDESTAL

© GAS EX. GAS VALVE & GAS LINE MARKER

EX. SANITARY SEWER

© S EX. SANITARY CLEANOUT & MANHOLE

EX. CLEANOUT & MANHOLE

EX. SQUARE, ROUND, & BEEHIVE CATCH BASIN

EX. UNIDENTIFIED STRUCTURE

PROPOSED TAPPING SLEEVE, VALVE & WELL

PROPOSED POST INDICATOR VALVE

○ C.O. ■ PROPOSED STORM SEWER CLEANOUT & MANHOLE

OC.O. PROPOSED SANITARY CLEANOUT & MANHOLE

PROPOSED CATCH BASIN, INLET & YARD DRAIN

➤ PROPOSED HYDRANT AND GATE VALVE

EX. STORM SEWER

EX. YARD DRAIN & ROOF DRAIN

PROPOSED SANITARY SEWER

PROPOSED STORM SEWER

— — — PROPOSED WATER MAIN

- - EX. GAS LINE

-UG-COMM---⊠-Ū- EX. U.G. COMMUNICATION LINE, PEDESTAL & MANHOLI JG-ELEC-E-E-EX. U.G. ELEC,MANHOLE, METER & HANDHOLE

EX. TRANSFORMER & IRRIGATION VALVE


EX. WATER VALVE BOX & SHUTOFF

EX. COMBINED SEWER MANHOLE

EX. HYDRANT, GATE VALVE & POST INDICATOR VALVE


www.peagroup.com



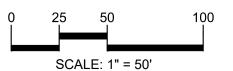



CAUTION!! THE LOCATIONS AND ELEVATIONS OF EXISTING UNDERGROUND UTILITIES AS SHOWN ON THIS DRAWING ARE ONLY APPROXIMATE. NO GUARANTEE IS EITHER EXPRESSED OR IMPLIED AS TO THE COMPLETENESS OR ACCURACY THEREOF. THE CONTRACTOR SHALL BE EXCLUSIVELY RESPONSIBLE FOR DETERMINING THE EXACT UTILITY LOCATIONS AND ELEVATIONS PRIOR TO THE START OF CONSTRUCTION.

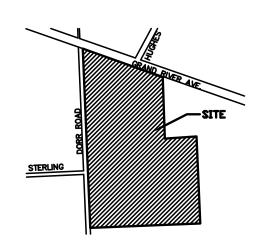

GRAND RIVER DORR LLC. 315550 NORTHWESTERN HIGHWAY FARMINGTON HILLS, MI 48334

6080 W GRAND RIVER

REVISIONS

PROJECT TITLE THE LEGACY APARTMENT HOMES

GENOA TOWNSHIP, LIVINGSTON COUNTY, MICHIGAN

REVISED PER TWP COMMENTS 6.23.22


ORIGINAL ISSUE DATE: MAY 24, 2022 DRAWING TITLE


CONCEPTUAL UTILITY PLAN

2021-0578 PEA JOB NO. JMR

NOT FOR CONSTRUCTION


DRAWING NUMBER:

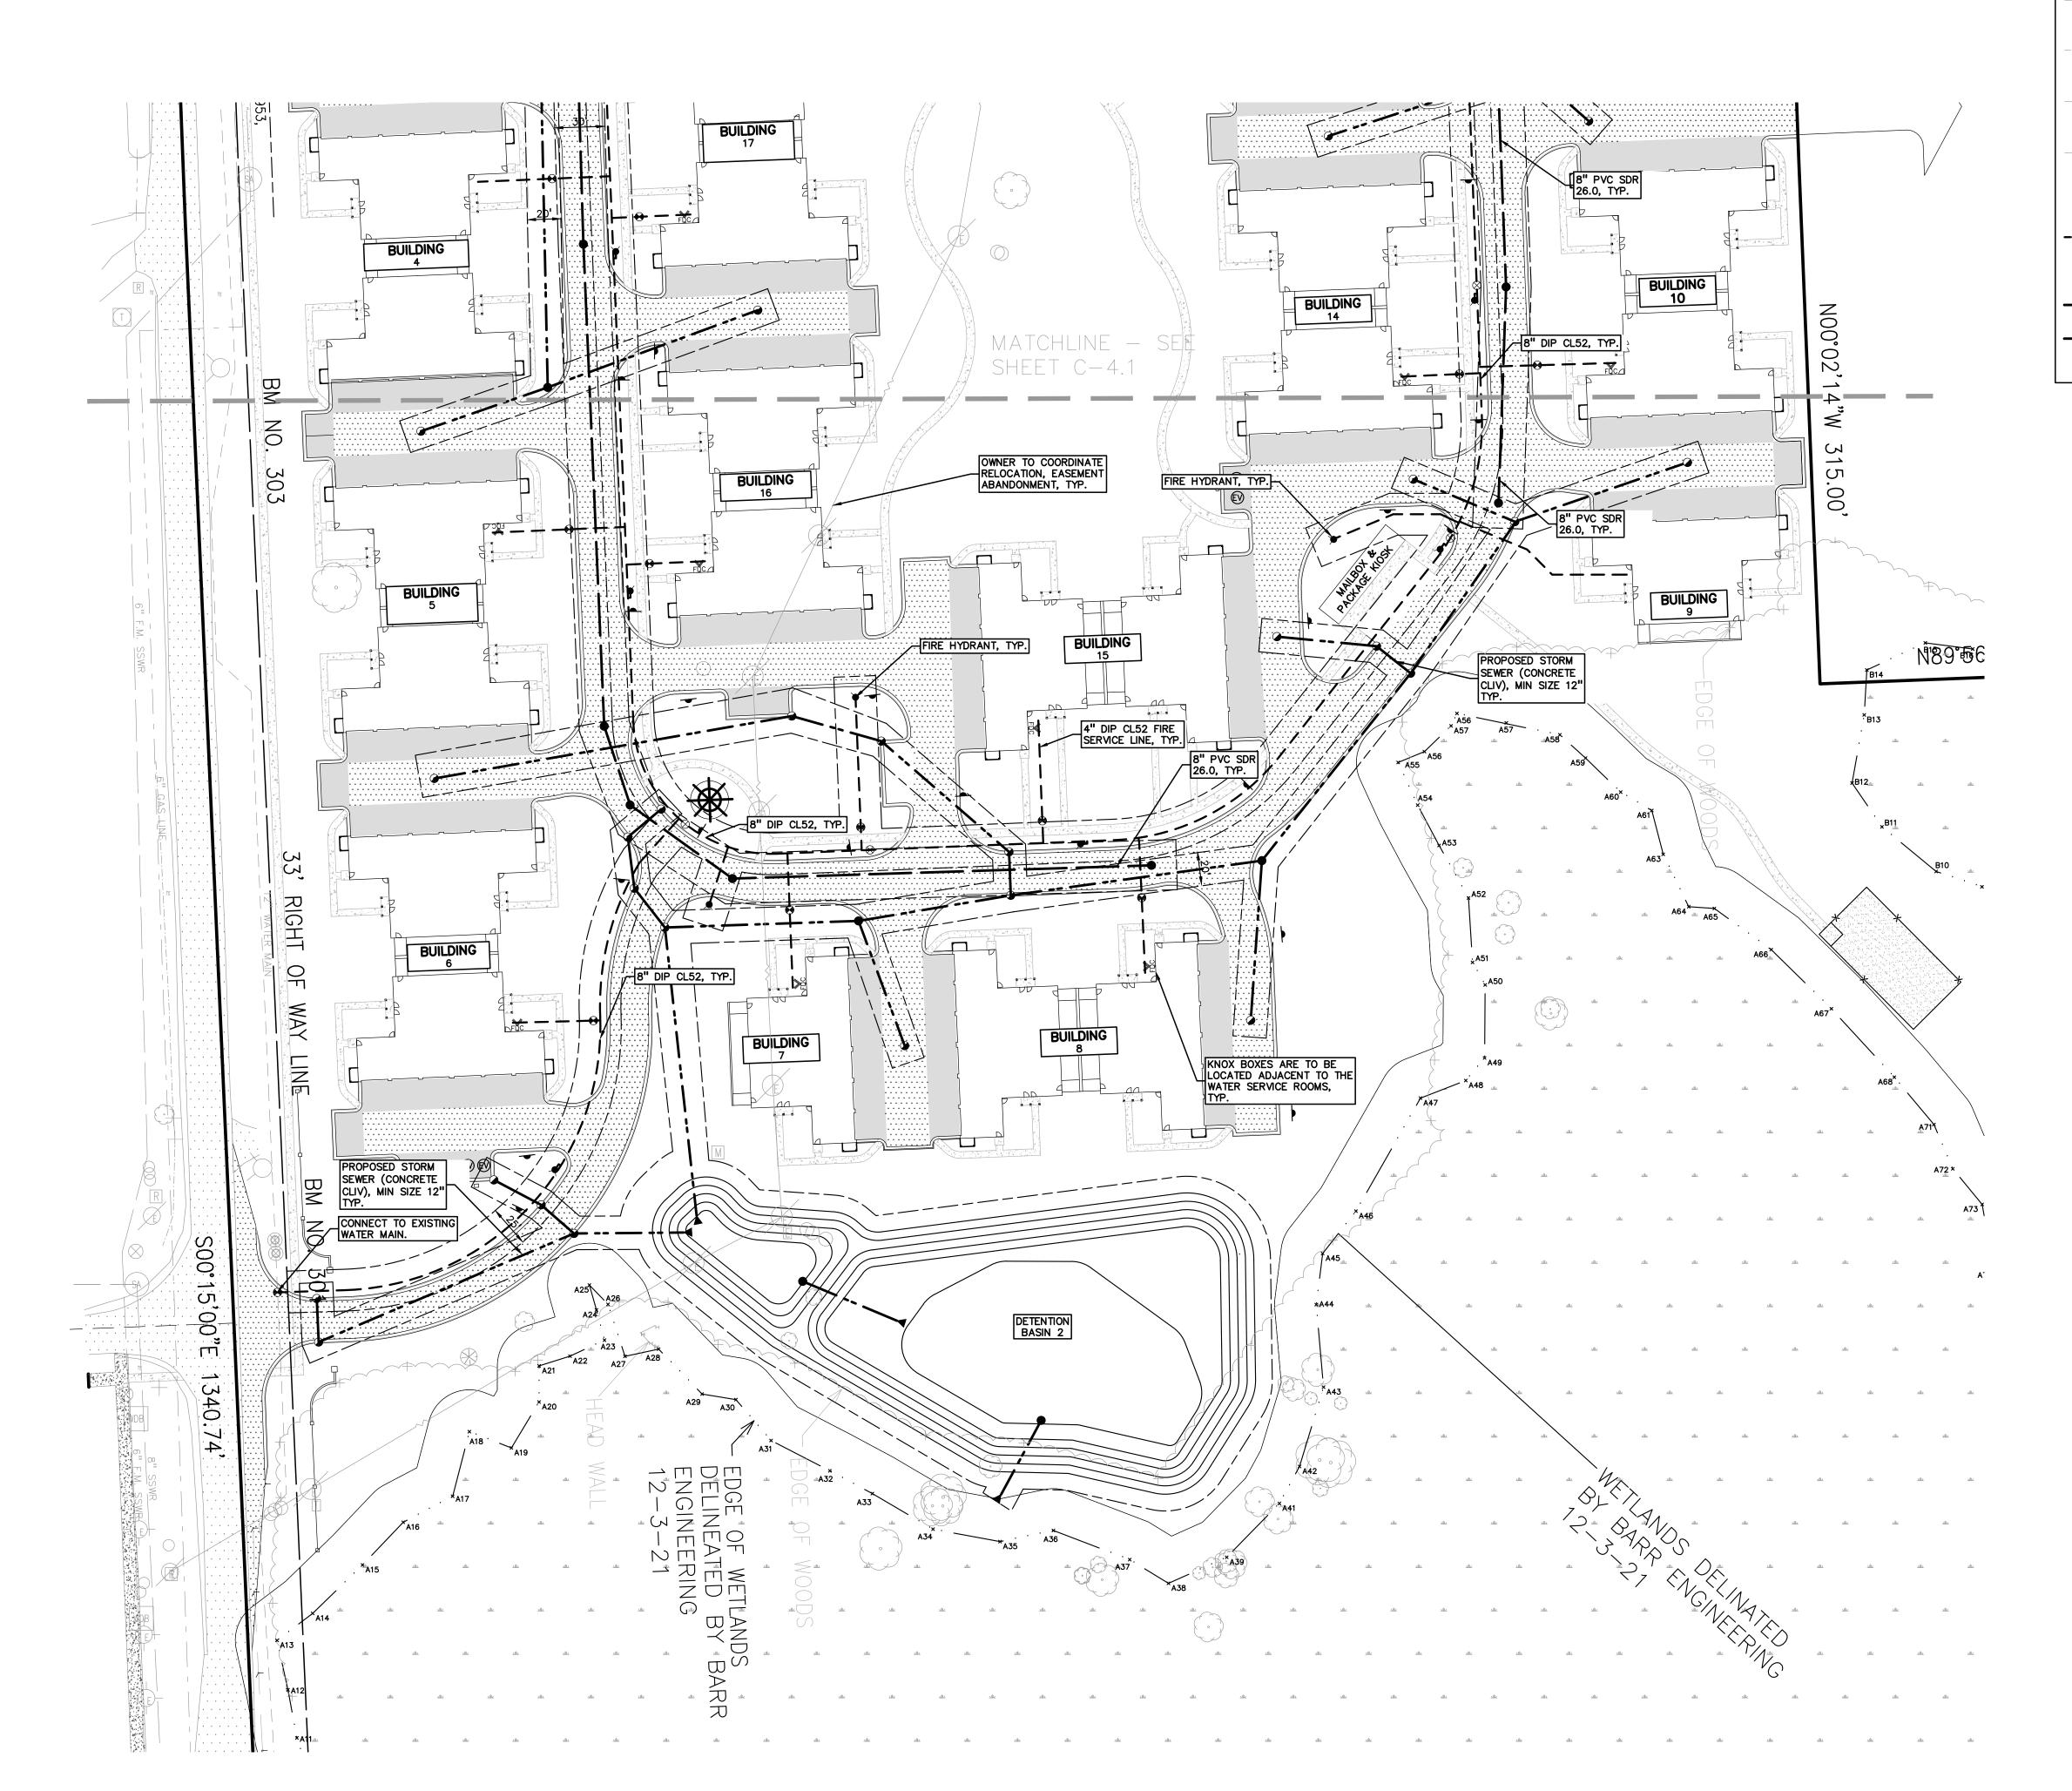

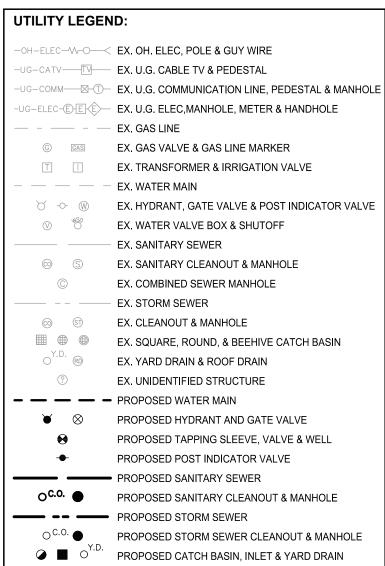






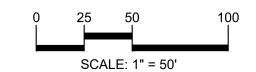



CAUTION!! THE LOCATIONS!

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CLIENT **GRAND RIVER DORR LLC.** 315550 NORTHWESTERN HIGHWAY FARMINGTON HILLS, MI 48334

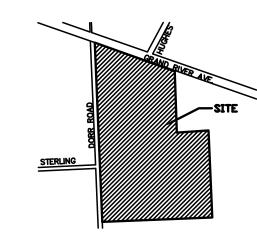PROJECT TITLE


THE LEGACY APARTMENT HOMES
6080 W GRAND RIVER
GENOA TOWNSHIP, LIVINGSTON COUNTY, MICHIGAN

REVISED PER TWP COMMENTS 6.23.22

ORIGINAL ISSUE DATE: MAY 24, 2022

CONCEPTUAL **UTILITY PLAN**


PEA JOB NO.	2021-0578
P.M.	JEC
DN.	JMR
DES.	JMR
DRAWING NUMBER:	

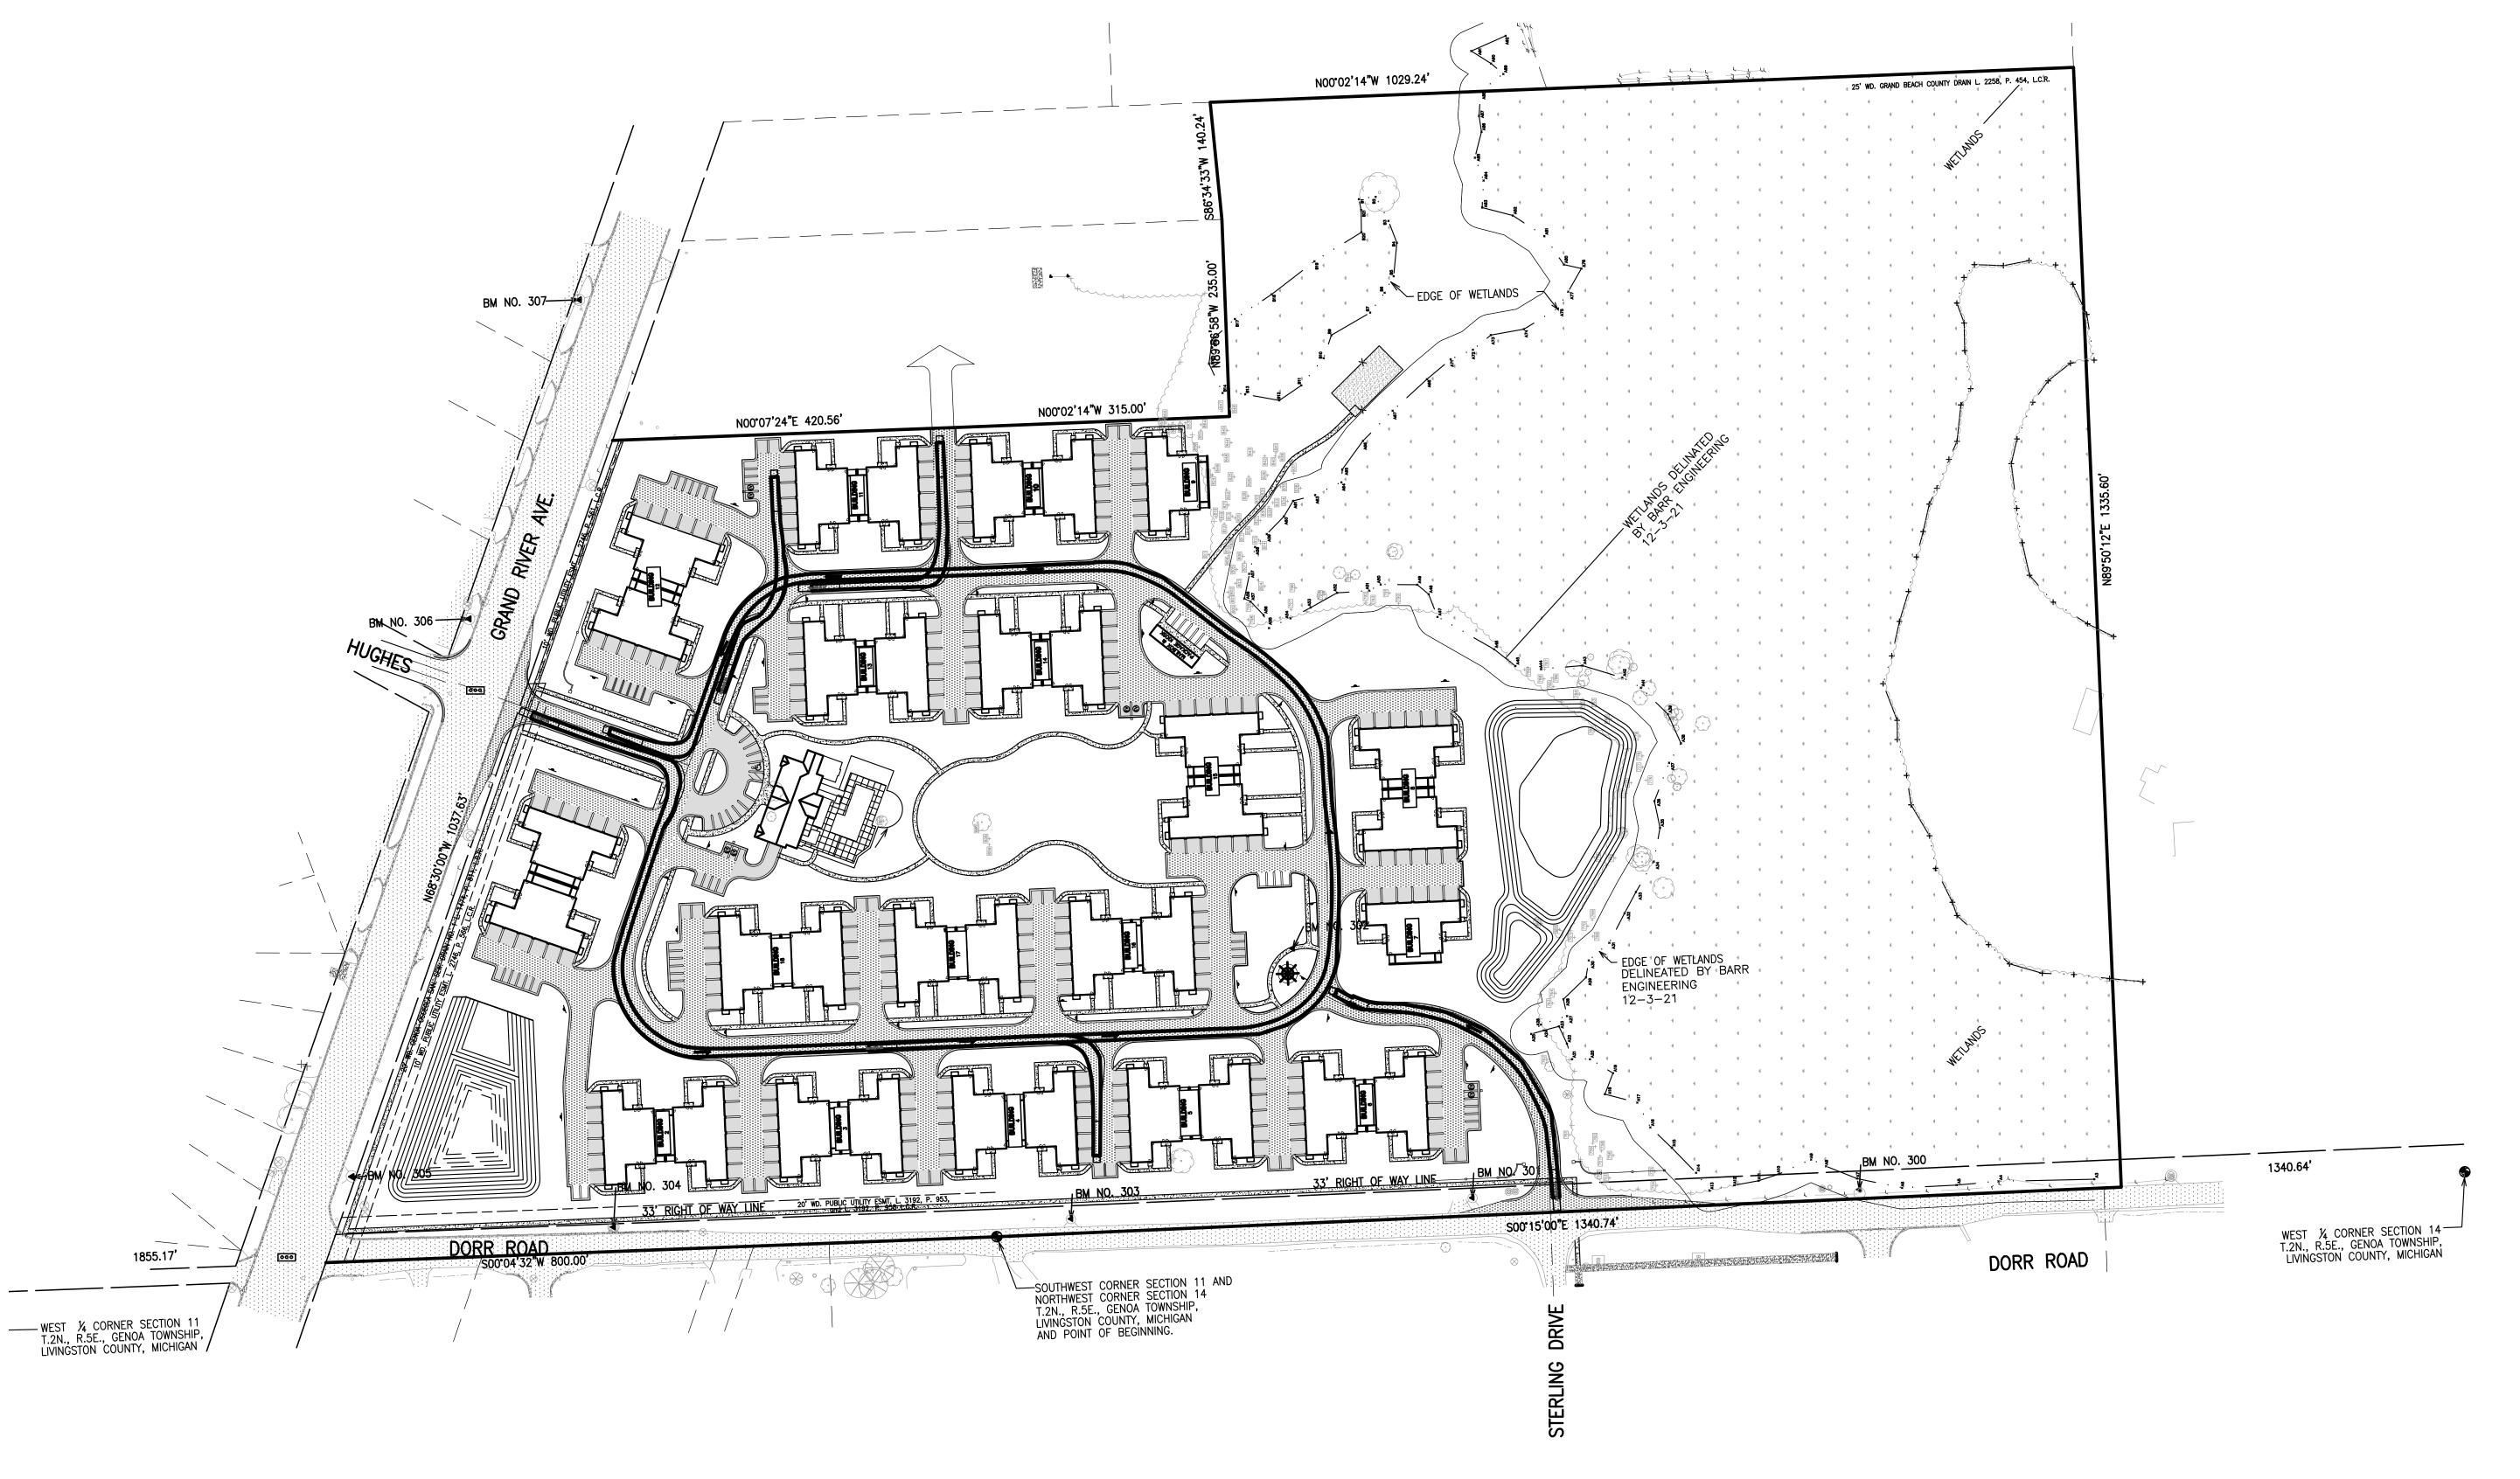



CAUTION!!

THE LOCATIONS AND ELEVATIONS OF EXISTING UNDERGRUTHILITIES AS SHOWN ON THIS DRAWING ARE ONLY APPROXIMATE. NO GUARANTEE IS EITHER EXPRESSED OI IMPLIED AS TO THE COMPLETENESS OR ACCURACY THER. THE CONTRACTOR SHALL BE EXCLUSIVELY RESPONSIBLE DETERMINING THE EXACT UTILITY LOCATIONS AND ELEVA PRIOR TO THE START OF CONSTRUCTION.

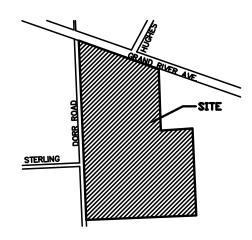

CLIENT

GRAND RIVER DORR LLC.
315550 NORTHWESTERN HIGHWAY
FARMINGTON HILLS, MI 48334

PROJECT TITLE

THE LEGACY APARTMENT
HOMES

6080 W GRAND RIVER
GENOA TOWNSHIP, LIVINGSTON COUNTY, MICHIGAN

REVISIONS
REVISED PER TWP COMMENTS 6.23.22

ORIGINAL ISSUE DATE: MAY 24, 2022

> VEHICLE TRACKING

DRAWING TITLE

PEA JOB NO. 2021-0578

P.M. JEC

DN. JMR

DES. JMR

DRAWING NUMBER:

 N C-5.1




Hollies, Dogwood, etc.)

evergreen shrubs

perennials and/or seasonal

(Daylily, Sedum, Ornamental Grasses,

Black Eyed Susan, Coneflowers, etc...)

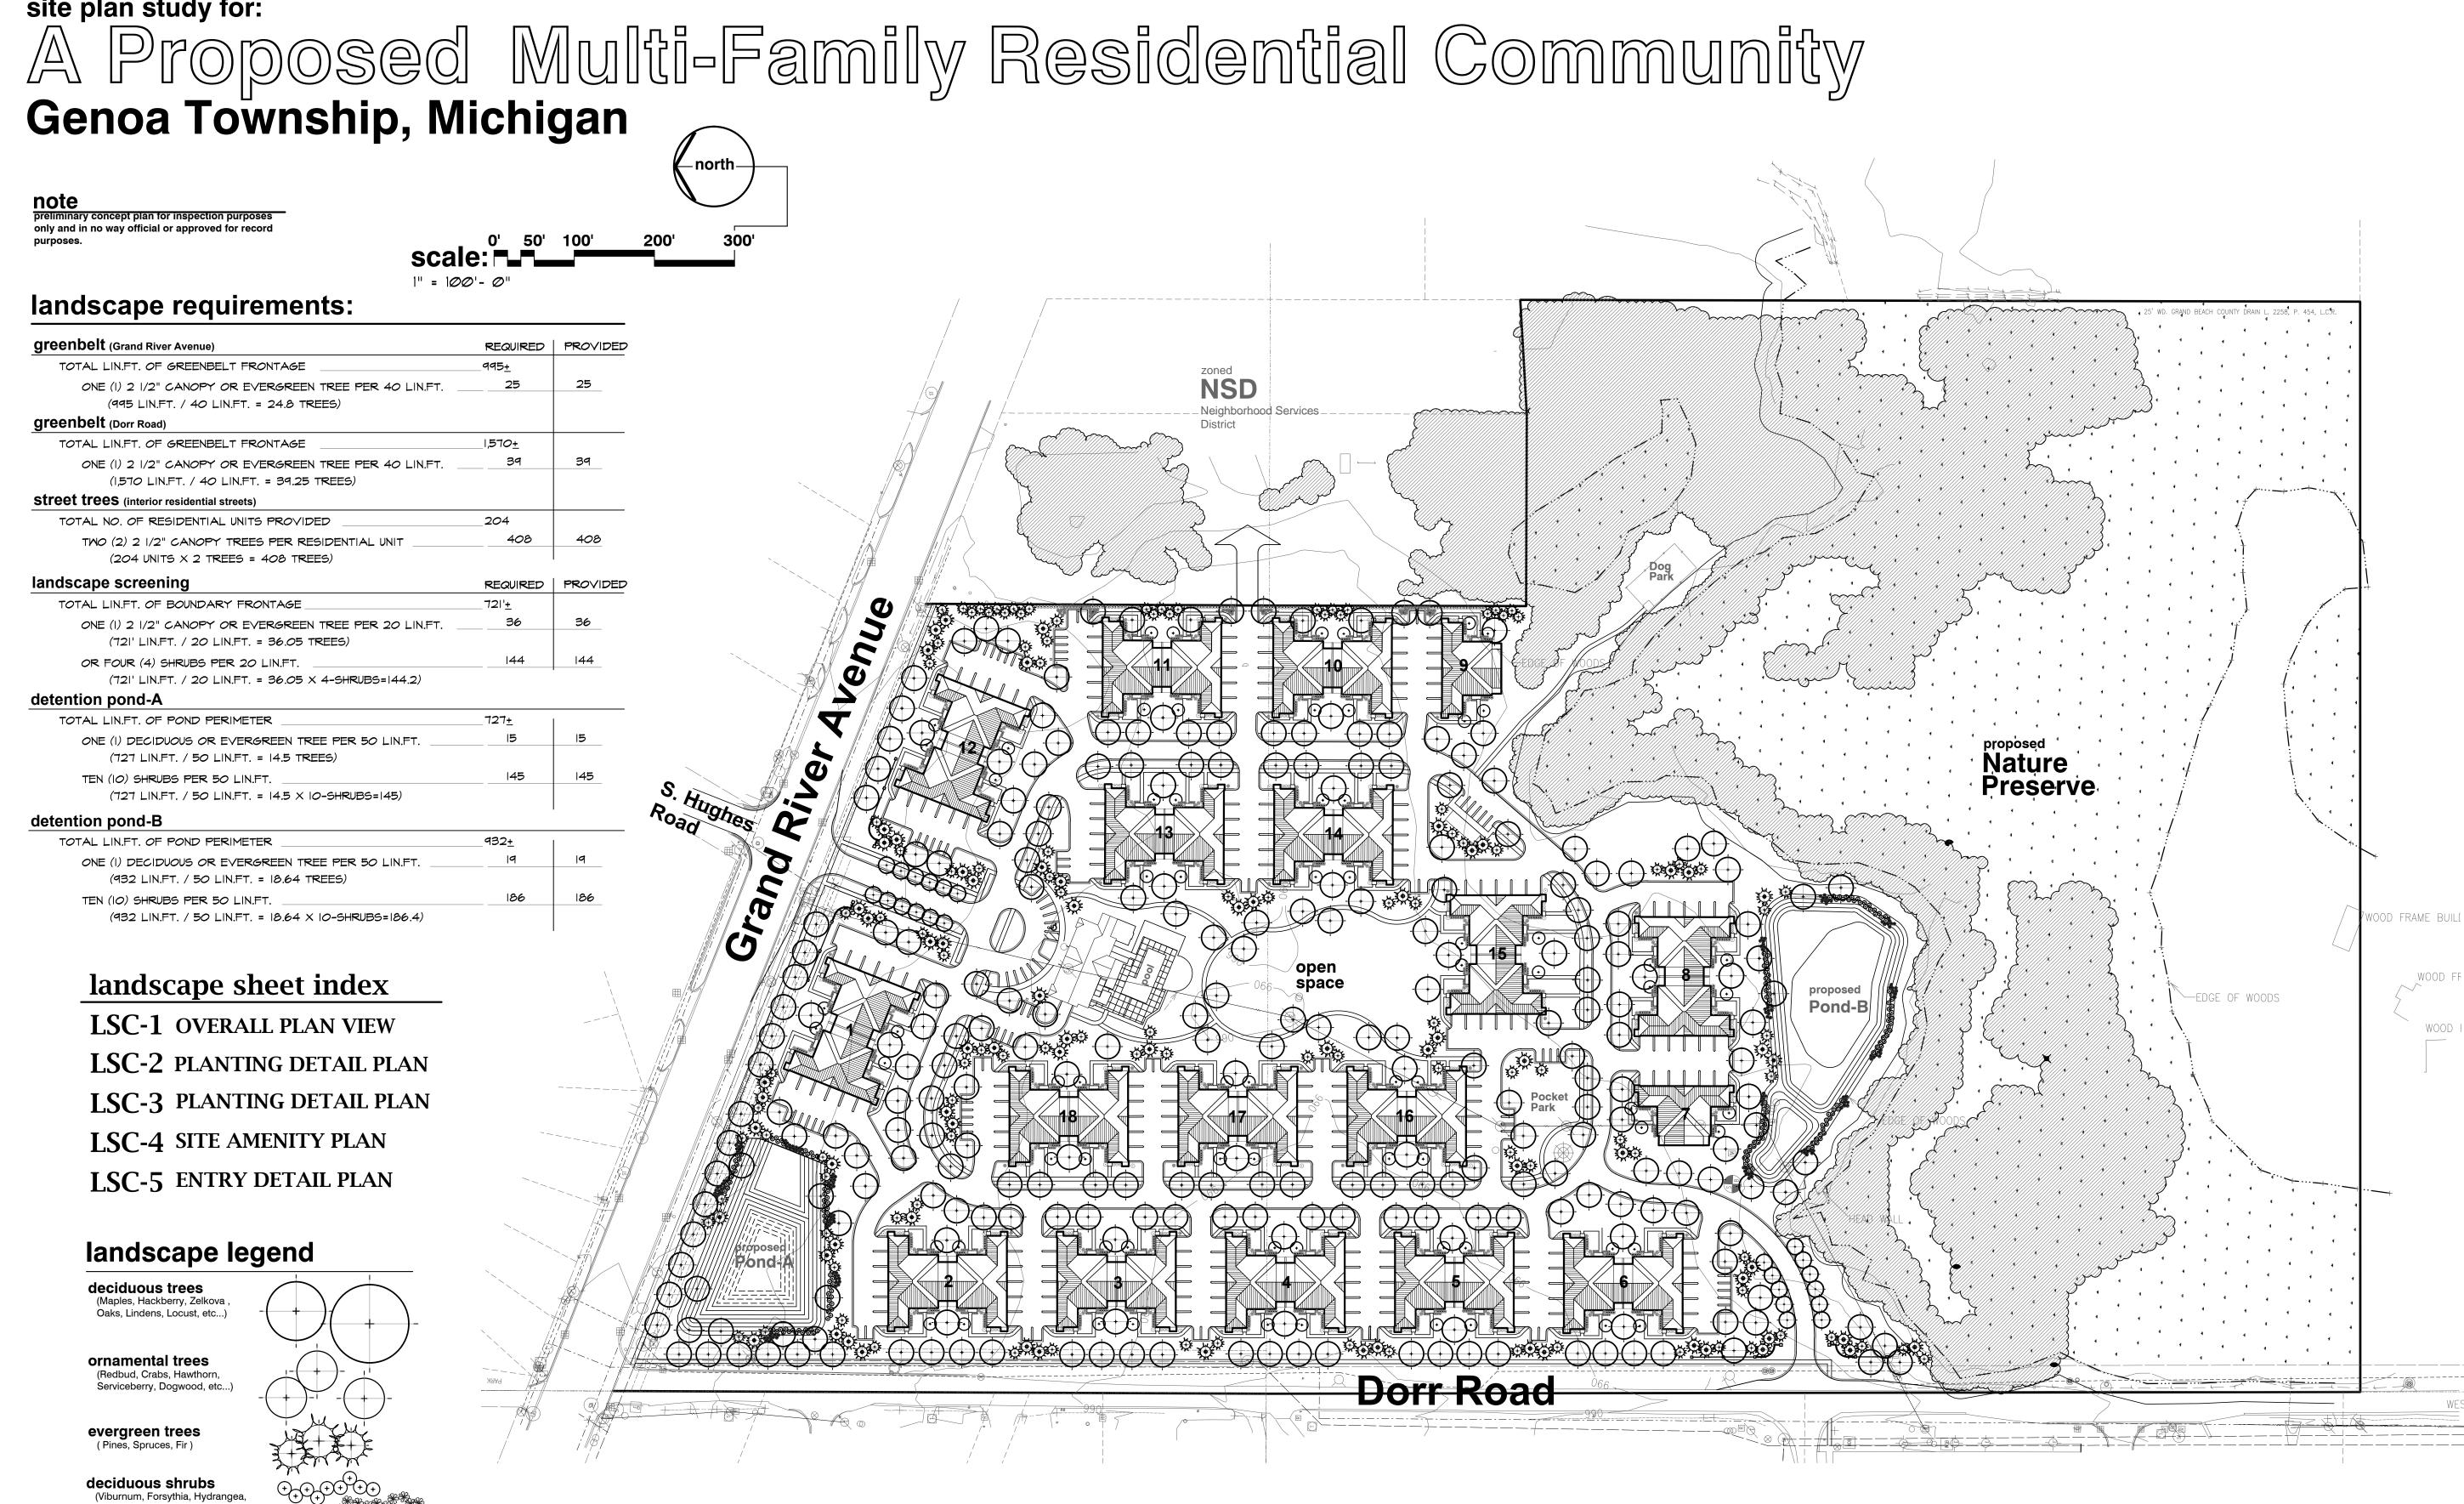



LAUTREC

31550 Northwestern HWY. Suite 200 Farmington Hills, Michigan 48334

project:

THE LEGACY APARTMENT HOMES

project location: Genoa Township, Michigan 12 Mile Road

sheet title:

CONCEPTUAL LANDSCAPE PLAN

job no./issue/revision date: LS21.096.08 SPA 8-18-2021 LS21.096.10 SPA 10-8-2021

LS21.096.10 SPA 10-24-2021 LS21.096.12 SPA 12-13-2021 LS22.028.02 SPA 2-24-2022 LS22.028.04 SPA 4-18-2022

drawn by: **JP, HP, DK**

checked by:

2-22-2022 notice:

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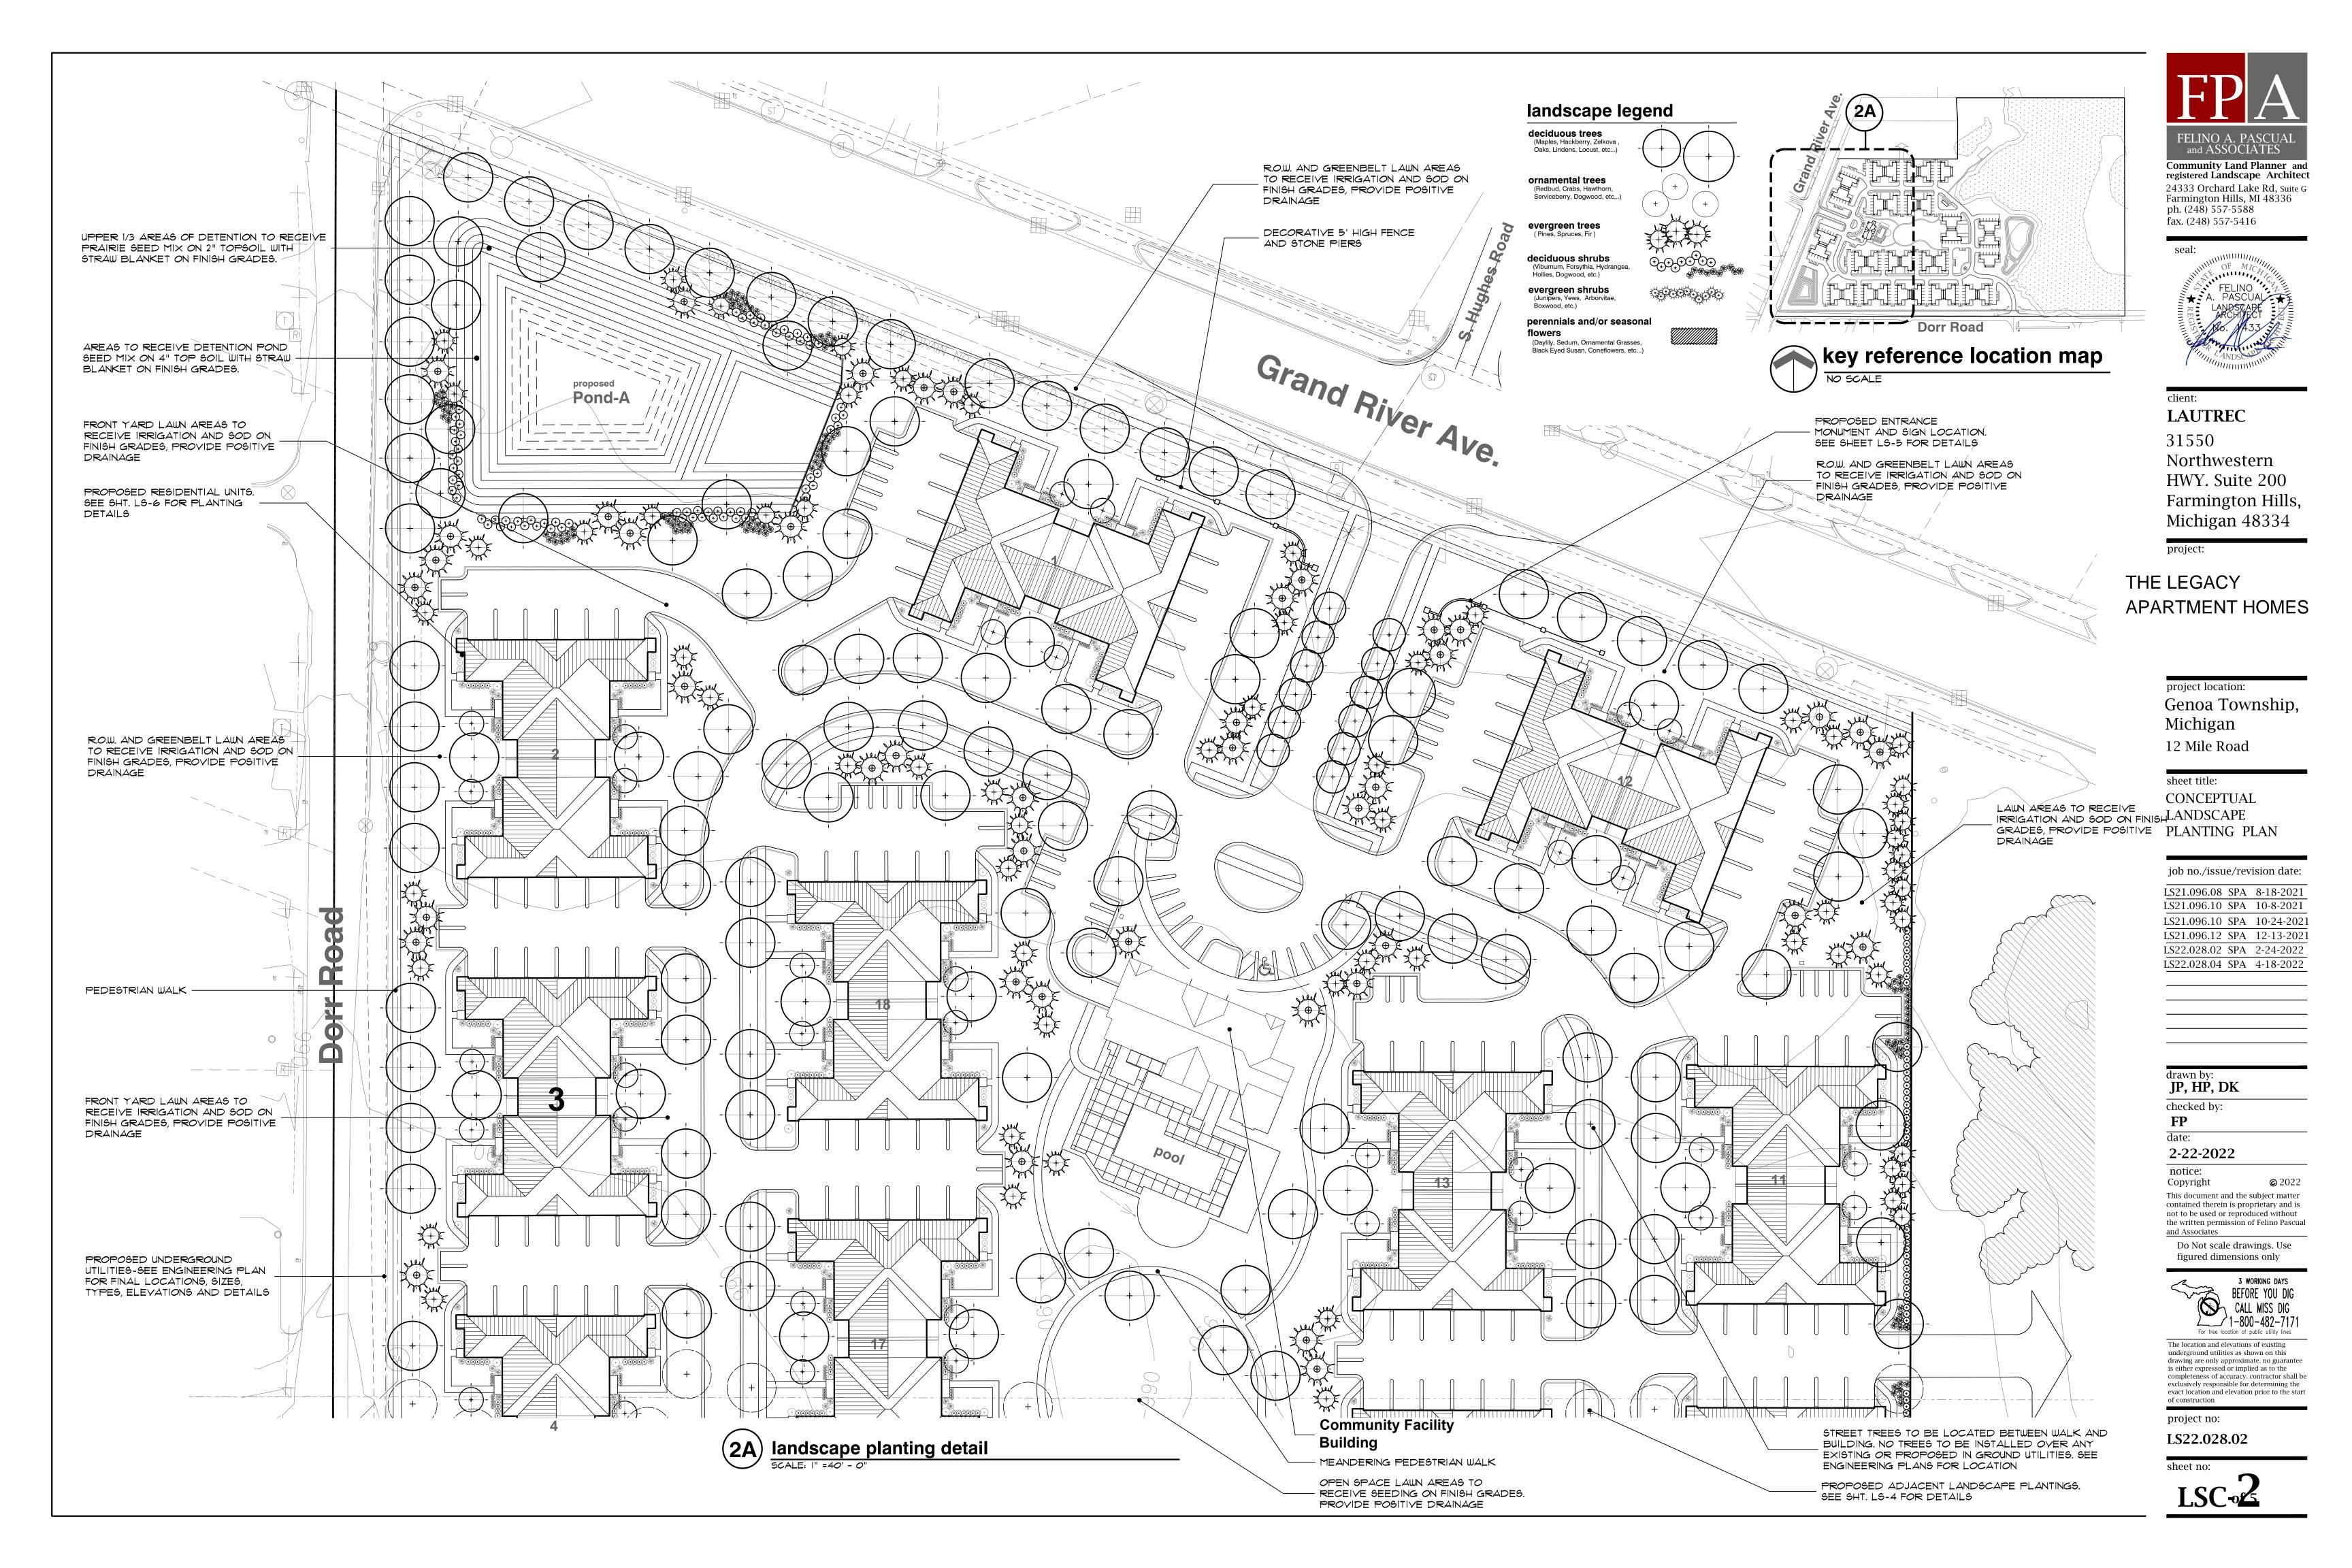



The location and elevations of existing exclusively responsible for determining the exact location and elevation prior to the start


project no: LS22.028.02

sheet no:

LSC-of



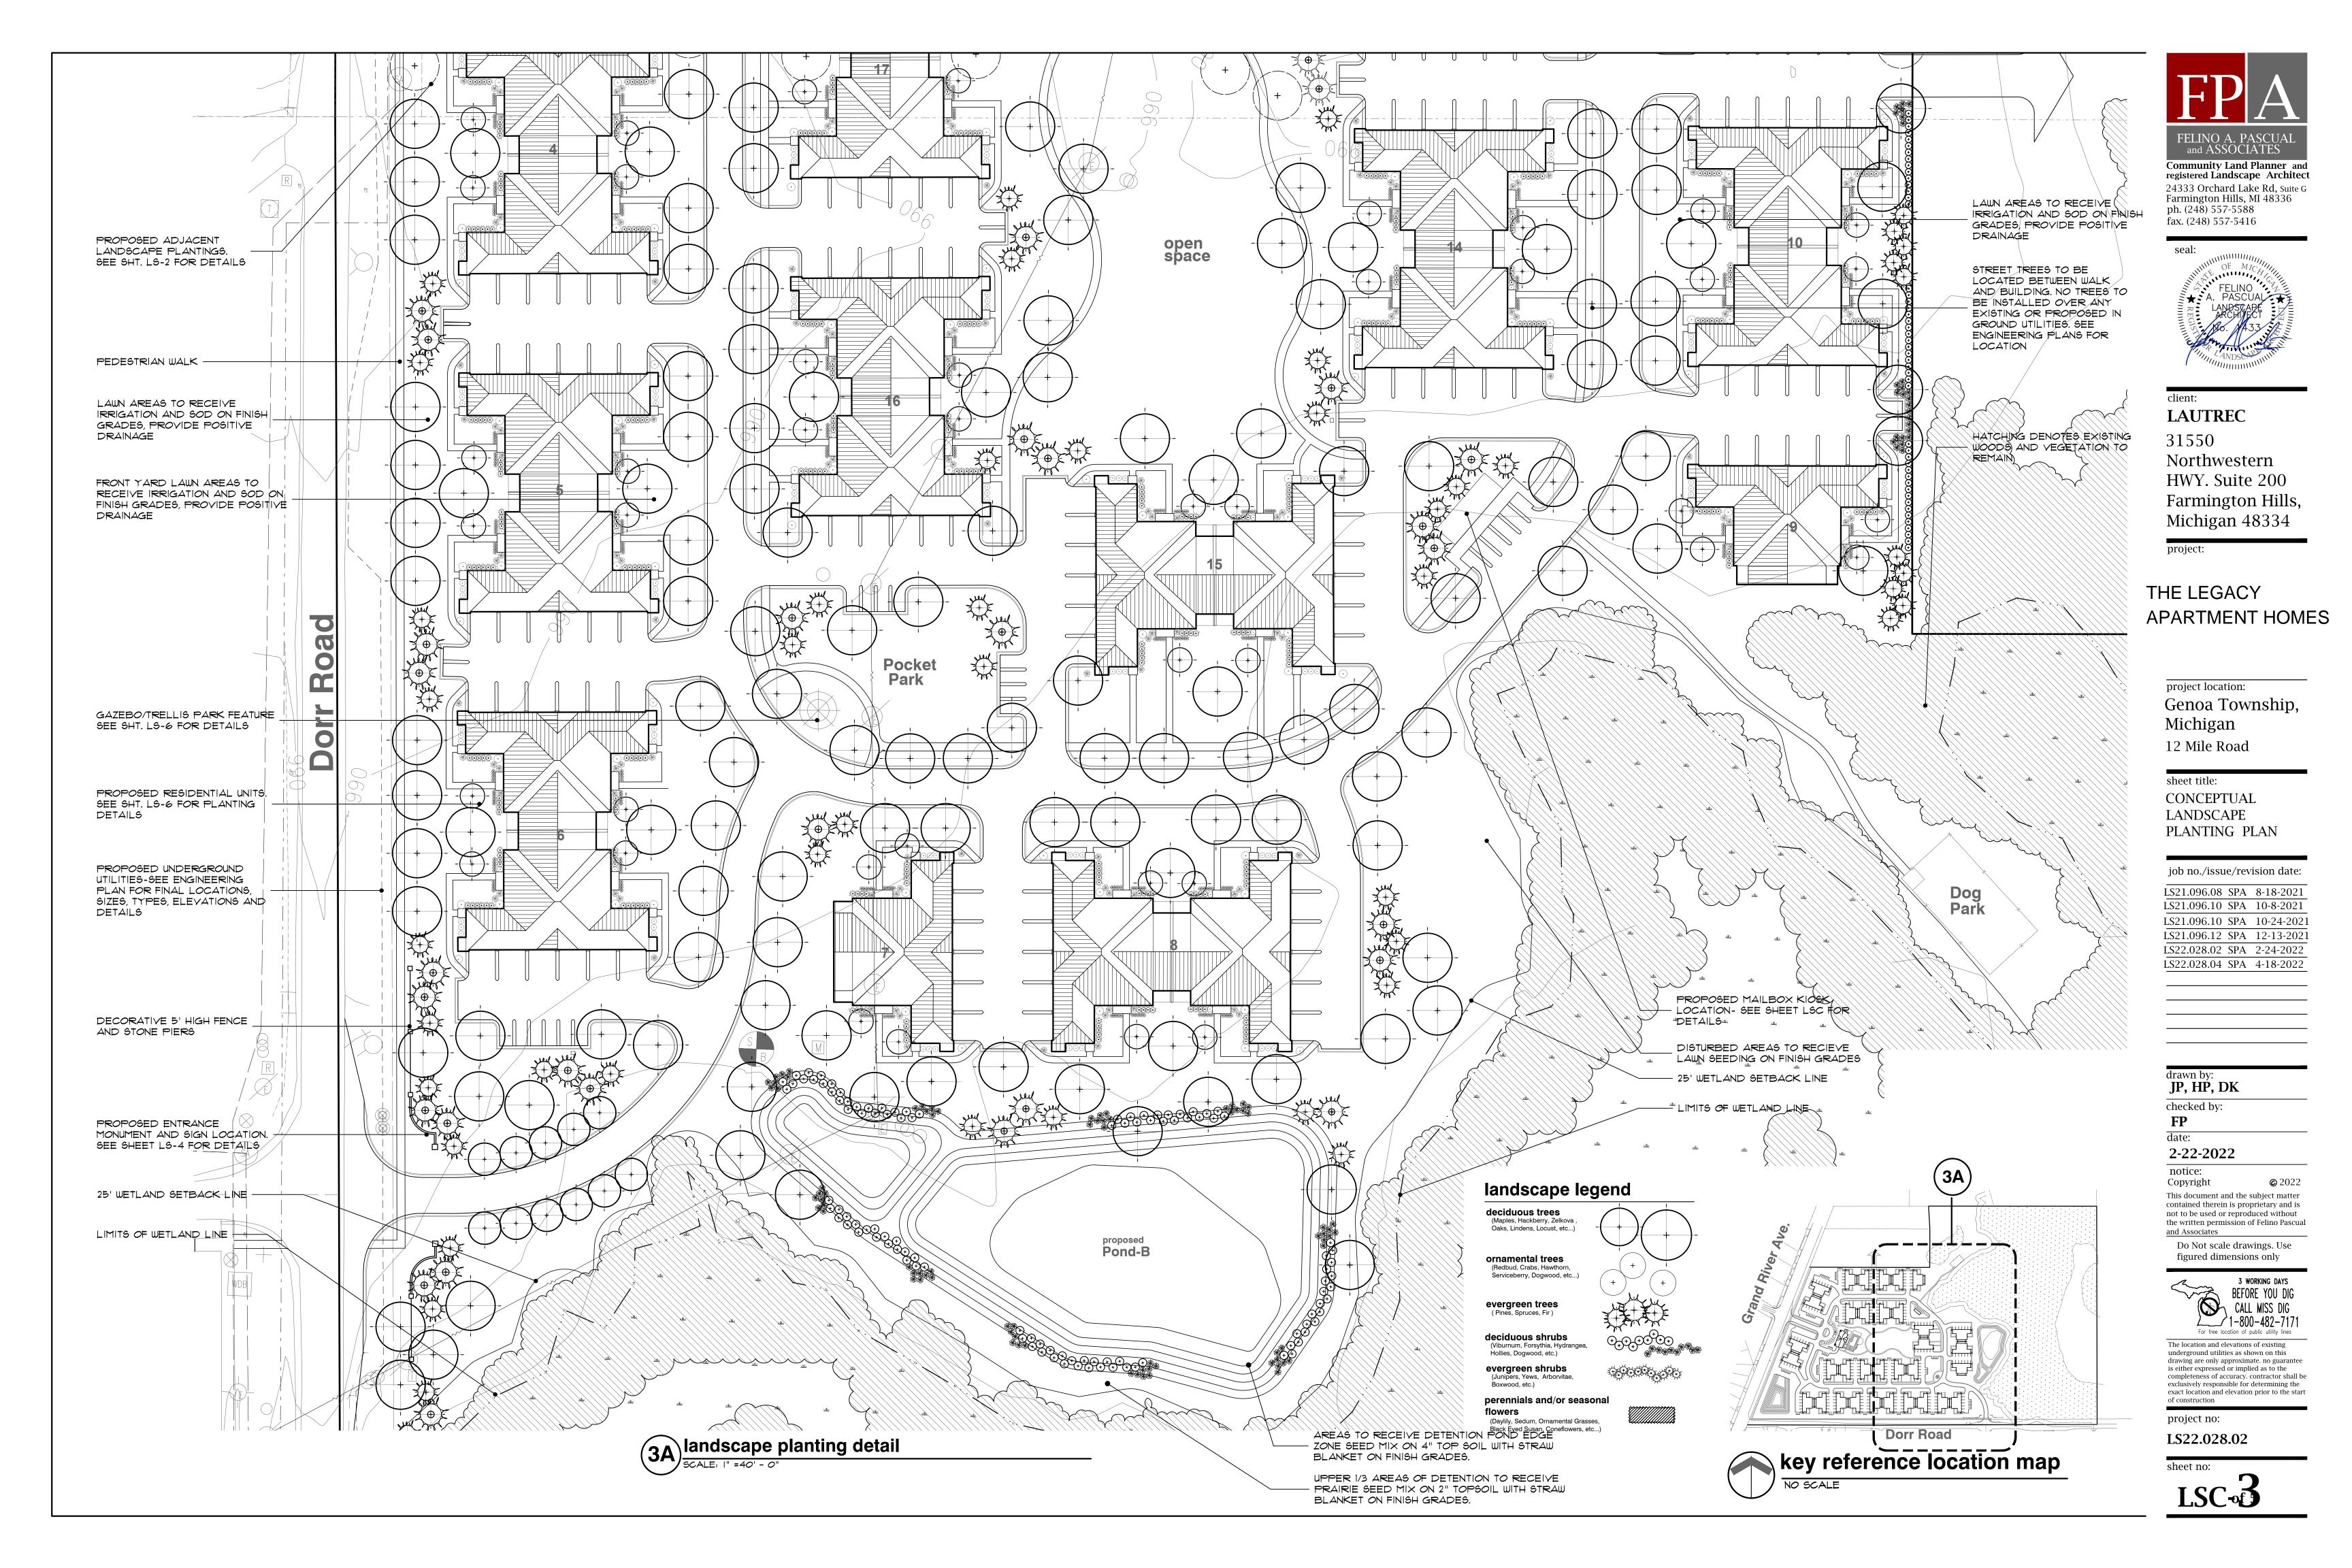

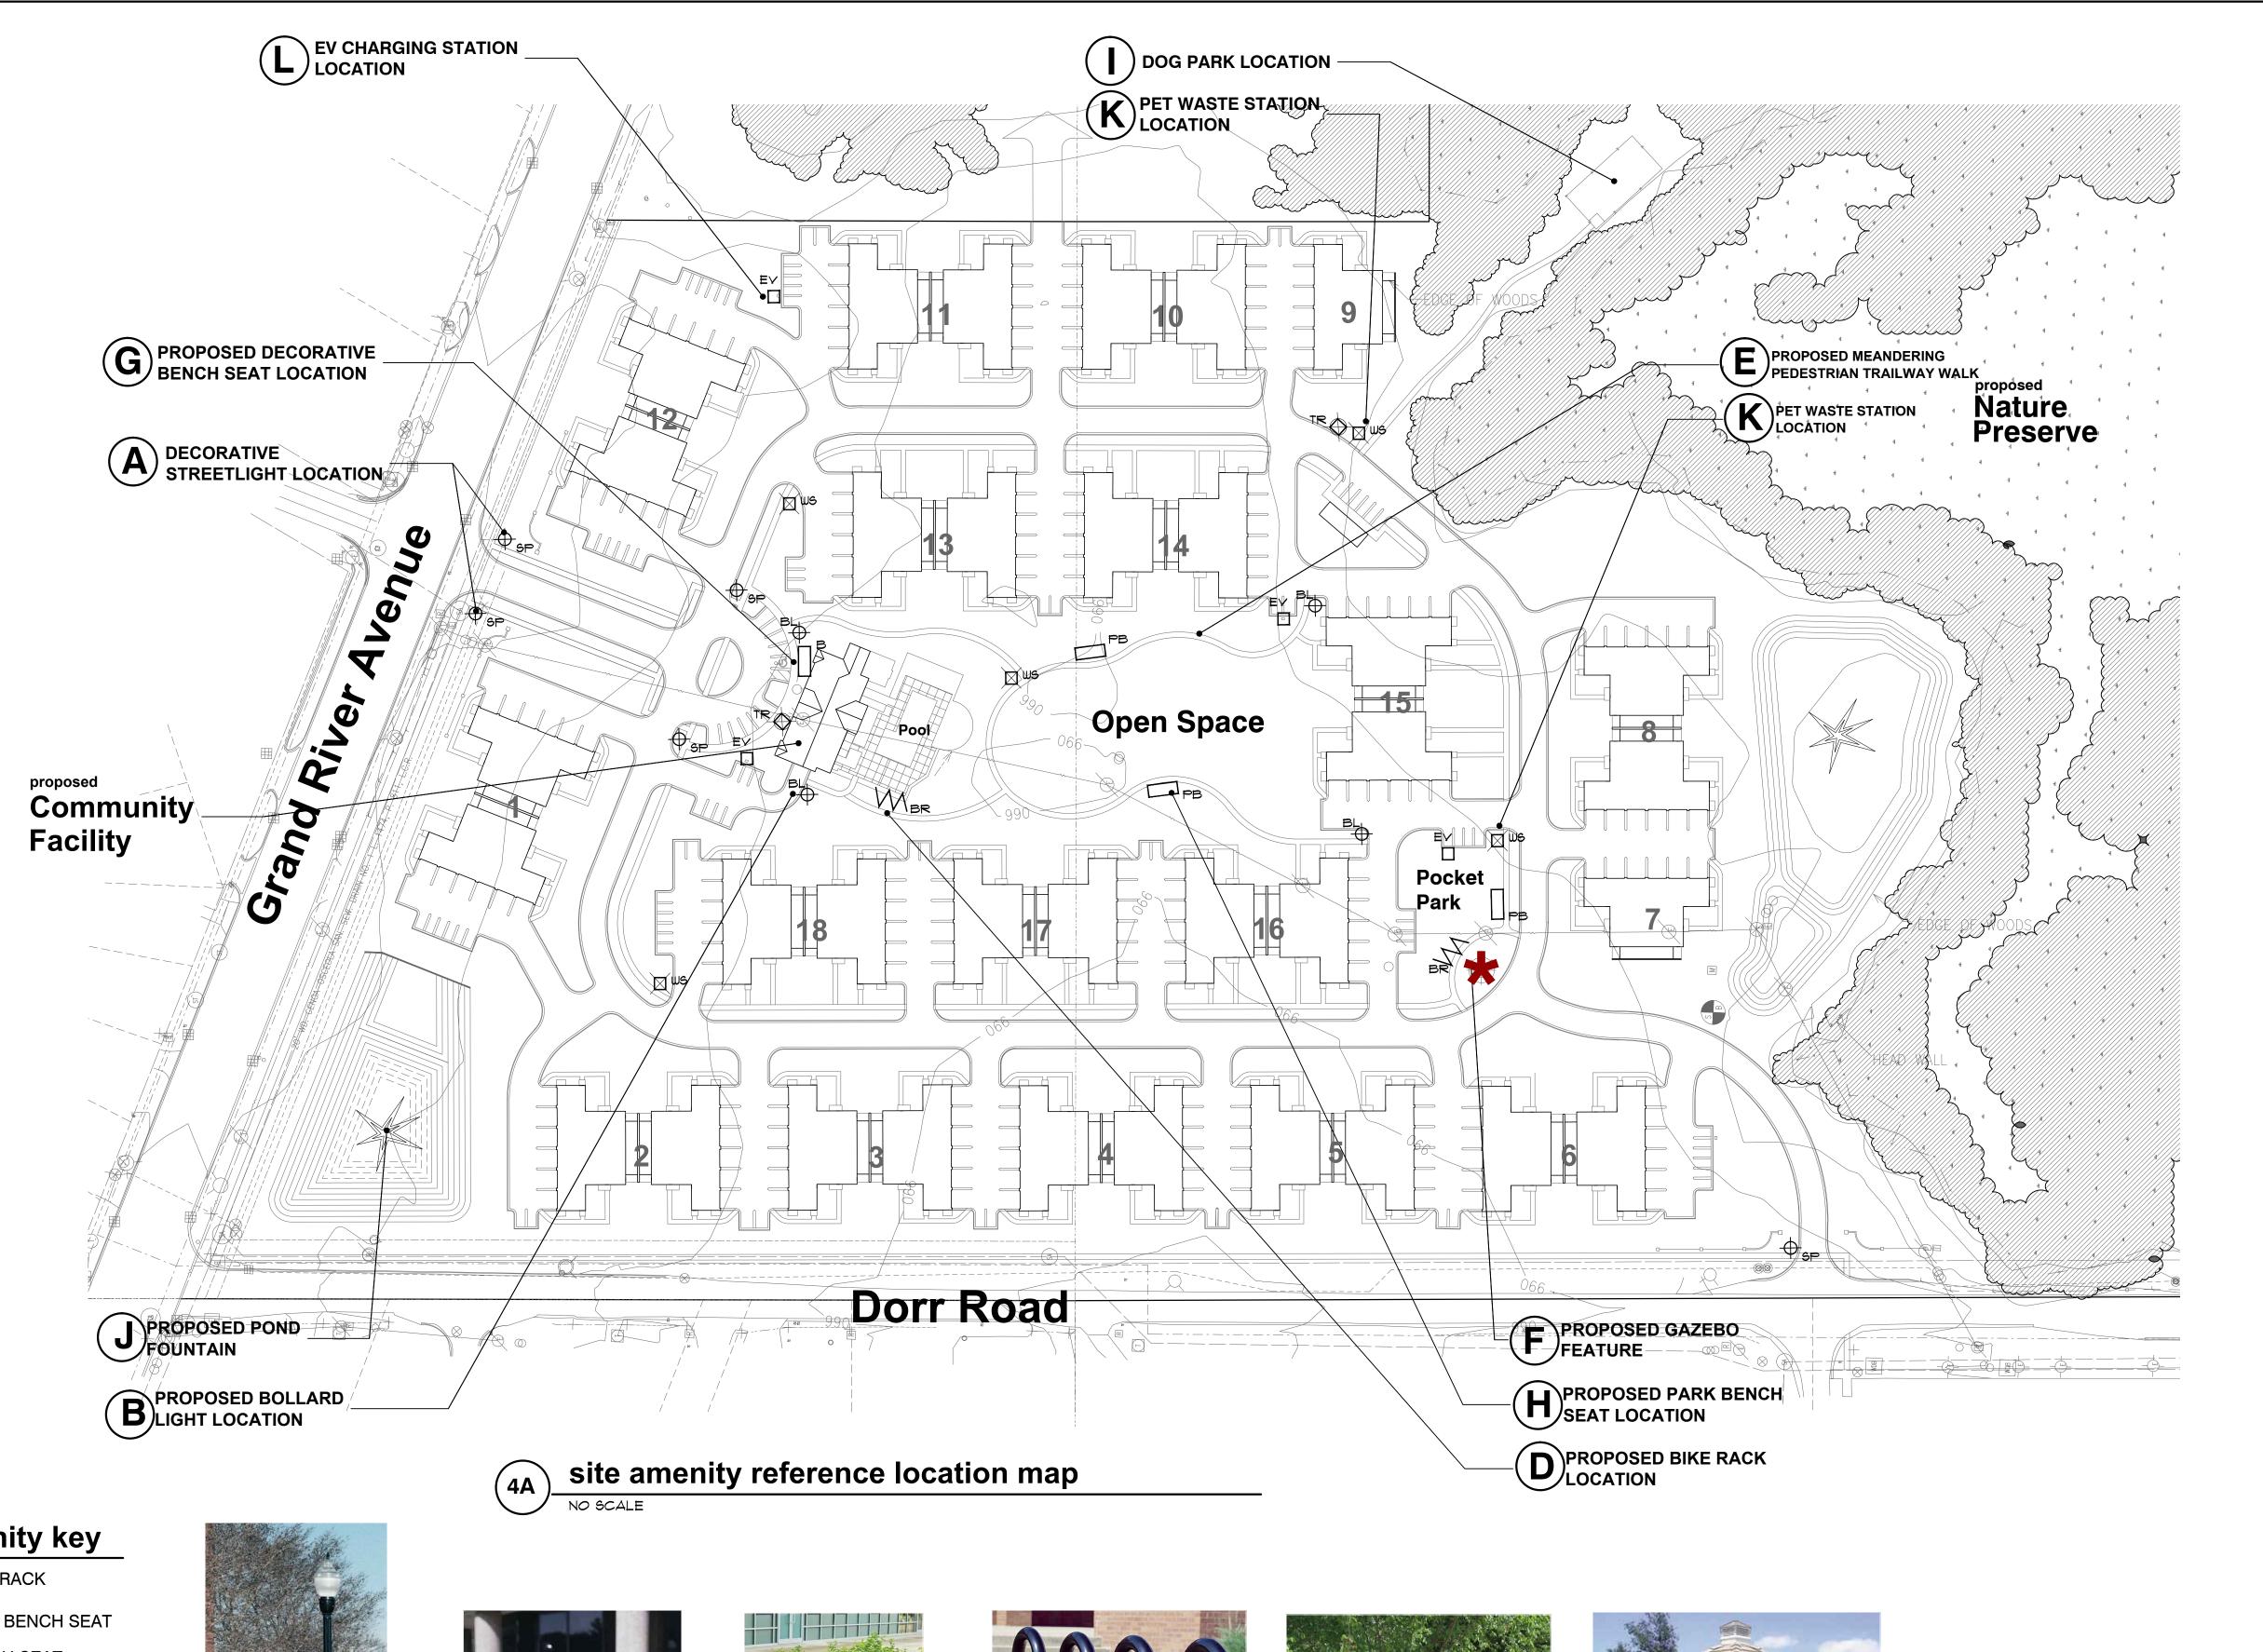



EV charging station



BY ZERO WASTE USA
12316 WORLD TRADE
DRIVE #102
SAN DIEGO, CA. 92128
PH. 800-789-2563
WWW: ZEROWASTEUSA.COM

MODEL NO.
JJB006-BLACK
DESCRIPTION: SENTRY
DOG WASTE STATION
(73"H X | 13"W)

pet waste station



pond fountain

TOTAL OF 2-CONDITIONS



dog park

park bench seating

TOTAL OF 3-CONDITIONS
6' WIDE PARK BENCH SEAT BY DUMOR, INC.
MODEL NO. 34-60D (S-I)
SUPPORT: S-I EMBEDMENT
FINISH: BLACK POWER-COATED



LAUTREC
31550

Northwestern HWY. Suite 200 Farmington Hills, Michigan 48334

FELINO A. PASCUAI and ASSOCIATES

Community Land Planner and registered Landscape Architect

24333 Orchard Lake Rd, Suite G Farmington Hills, MI 48336 ph. (248) 557-5588 fax. (248) 557-5416

project:

THE LEGACY APARTMENT HOMES

project location: Genoa Township, Michigan

12 Mile Road

sheet title:

CONCEPTUAL SITE AMENITY PLAN

job no./issue/revision date:

LS21.096.08 SPA 8-18-2021
LS21.096.10 SPA 10-8-2021
LS21.096.10 SPA 10-24-2021
LS21.096.12 SPA 12-13-2021
LS22.028.02 SPA 2-24-2022

LS22.028.04 SPA 4-18-2022

drawn by:

JP, HP, DK checked by:

FP date:

2-22-2022 notice:

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project no:

LS22.028.02

sheet no:
LSC-4 of 5

site amenity key

₩ BIKE RACK

PB PARK BENCH SEAT


⊕_B BOLLARD LIGHT

⊕_{SP} STREET POLE LIGHT

GAZEBO or PERGOLA FEATURE

DESCRIPTION

TRASH RECEPTACLE

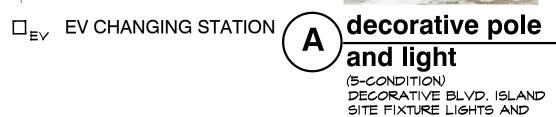

ALUMINUM POLE.



bollard light

By LITHONIA LIGHTS OR
EQUAL MODEL. DSXB LED
(D-SERIES LED BOLLARD
8"DIA.X42" HST.) OR

EQUAL (4-CONDITIONS)



trash receptacle
(2-CONDITION)
MANUFACTURED BY BY
ANOVA, INC.
WMW: ANOVAFURNISHINGS.COM
DESCRIPTION: 32 GAL

FINISH: TEXTURE PEWTER



bicycle rack

(2-conditions)

BIKE RACK BY DUMOR, INC.

MODEL NO. 130-20 (5-2

SURFACE PLATE MOUNT) 2 3/8"

O.D. BLACK POWER-COATED

LOOP OR EQUAL



meandering interior pedestrian walk



gazebo feature

(I-CONDITIONS)

STICK BUILT OR KIT FORM.

TO BE BUILT BY MANUFACTURER
STANDARDS



decorative bench seating


TOTAL OF I-CONDITIONS

MANUFACTURED BY BY ANOVA, INC.

MUM: ANOVAFURNISHINGS.COM

MODEL NO. LEXC6

DESCRIPTION: 6' WIDE CONTOUR BENCH
FINISH: TEXTURE PEWTER

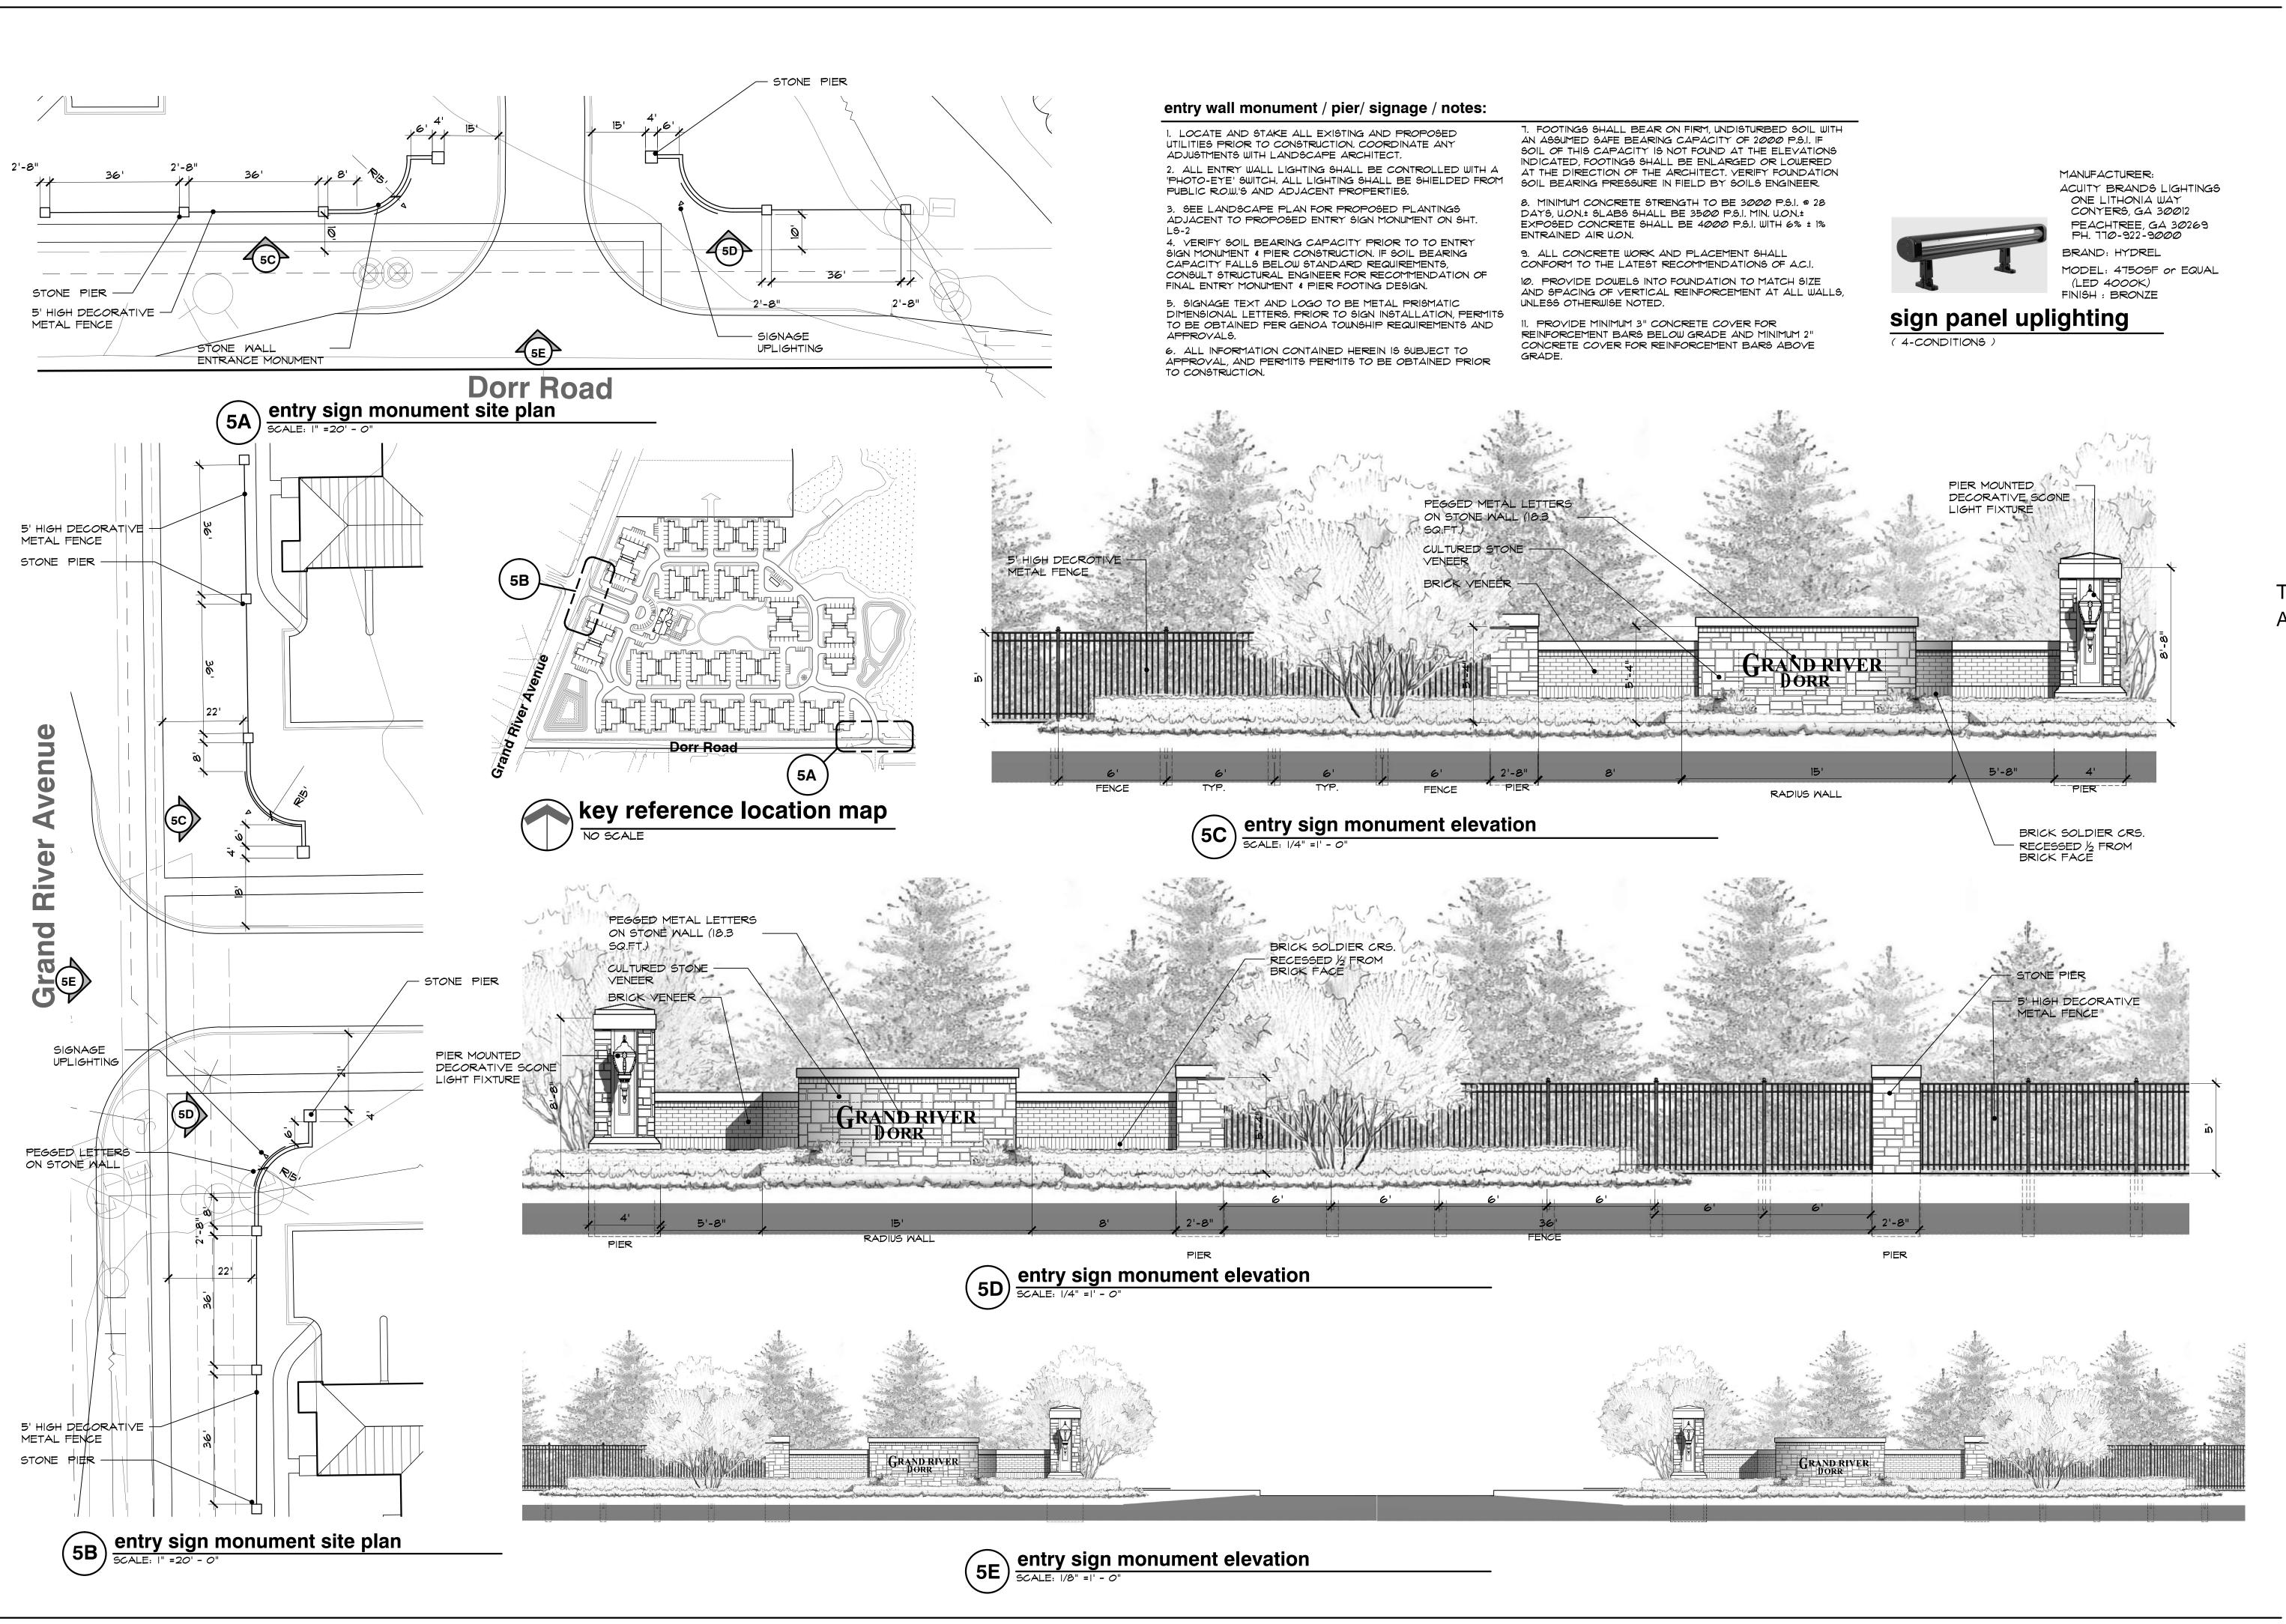



seal:

OF MICHAELING

FELINO

A. PASCUAL

ARCHITECT

ANDSCAPE

ARCHITECT

ANDSCAPE

ARCHITECT

ANDSCAPE

A

LAUTREC

31550 Northwestern HWY. Suite 200 Farmington Hills, Michigan 48334

project:

THE LEGACY APARTMENT HOMES

project location: Genoa Township, Michigan

sheet title:

12 Mile Road

CONCEPTUAL ENTRY SIGN MONUMENT

job no./issue/revision date:

LS21.096.08 SPA 8-18-2021
LS21.096.10 SPA 10-8-2021
LS21.096.10 SPA 10-24-2021
LS21.096.12 SPA 12-13-2021

LS22.028.02 SPA 2-24-2022

LS22.028.04 SPA 4-18-2022

drawn by: **JP, HP, DK**

checked by: **FP**

date: **2-22-2022**

notice:

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project no:

LS22.028.02

sheet no:

LSC-5 of 5

Notes:

Applicable Building Codes:

MICHIGAN BUILDING CODE 2015 STATE OF MICHIGAN ELECTRICAL CODE 2017 w/PART 8 AMENDMENTS MICHIGAN MECHANICAL CODE 2015 MICHIGAN PLUMBING CODE 2015 ANSI A117.1 - 2009 ACCESSIBILITY CODE INTERNATIONAL FIRE CODE 2015 MICHIGAN 2015 USE TYPE : R-2 (Apartments) U (Private Garages)

MICHIGAN 2015 CONSTRUCTION TYPE:

▼-B

Areas:

	R-2	U	Total
UNIT "A"	1,471 s/f	417 s/f	1,888 s/f
UNIT "B"	1,629 s/f	417 s/f	2,046 s/f
UNIT "C"	1,585 s/f	428 s/f	2,013 s/f
TOTAL PER QUADRANT:	4,685 s/f	1,262 s/f	5,947 s/f
TOTAL FOR HALF BUILDING:	9,370 s/f	2,524 s/f	11,894 s/f

A 2 HOUR FIRE WALL IS REQURED BETWEEN THE RIGHT & LEFT HALVES OF THE BUILDING. A 1 HOUR SEPERATION WILL BE PROVIDED BETWEEN THE 2 QUADRANTS. A 1 HOUR SEPERATION WILL PROVIDED BETWEEN THE FIRST FLOOR AND THE SECOND FLOOR A 1 HOUR SEPEATION WILL BE PROVIDED BETWEEN THE APARTMENTS AND THE PRIVATE GARAGE AREA. A 1 HOUR SEPERATION WILL BE PROVIDED BETWEEN

Occupancies:

1 OCCUPANT PER 200 s/f OF AREA PER TABLE 1004.1.2

THE SECOND FLOOR AREA AND THE ATTIC

UNIT "A"	1,471 s/f / 200 = 7
UNIT "B"	1,629 s/f / 200 = 8
UNIT "C"	1,585 s/f / 200 = 8
TOTAL PER QUADRANT:	4,518 s/f 23
TOTAL PER BUILDING:	92

Fire Supression:

A NFPA 13-R 2010 AUTOMATIC FIRE SUPPRESSION SYSTEM SHALL BE PROVIDED THROUGHTOUT ALL AREAS OF THE BUILDING INCLUDING GARAGES, BALCONIES AND GROUND FLOOR PATIOS AS PER CHAPTER 9 OF THEMBC- 2012. SMOKE ALARMS TO BE PROVIDED AS PER SECTION 907.2.9.2 & 907.2.11.2 OF THE MBC-2012. CARBON MONOXIDE ALARMS TO BE PROVIDED AS PER SECTION 908.7 OF THE MBC-2012.

ATTIC DRAFT STOPS:

EACH OF THE ATTICS ABOVE THE SECOND FLOOR UNITS ARE SEPERATED BY THE EXTENSION OF THE FIRE WALLS BELOW SEPERATING EACH UNIT. THESE WALLS EXTEND TO THE UNDERSIDE OF THE ROOF DECK. THE WALL SEPERATING THE RIGHT HALF OF THE BUILDING FROM THE LEFT HALF IS A 2 HOUR FIRE RATED WALL. THE WALL SEPERATING THE FRONT UNITS FROM THE REAR UNITS ARE A 1 HOUR WALL. EACH OF THE ATTIC SPACES IS LESS THAN THE MAXIMUM OF 3,000 s/f.

Seperate Submittals

1. SHOP DRAWINGS FOR ENGINEERED FLOOR JOIST SYSTEMS & PRE-ENGINEERED ROOF TRUSSES SYSTEMS. ALL DRAWINGS TO BE SIGNED AND SEALED BY A PROFESSIONAL ENGINEER IN THE STATE OF MICHIGAN.

2. FIRE SUPRESSION SYSTEM DESIGN DRAWINGS. ALL DRAWINGS TO BE SIGNED AND SEALED BY A PROFESSIONAL ENGINEER IN THE STATE OF MICHIGAN.

3. ALL INTERIOR FINISHES SHALL MEET A CLASS C FLAME SPREAD INDEX 76-200 AND SMOKE-DEVELOPED INDEX 0-450. PROVIDE PRODUCT CUT SHEETS TO THE BUILDING DEPARTMENT SHOWING COMPLIANCE.

Special Inspections:

ALL SPECIAL INSPECTIONS SHALL BE DONE BY McDOWELL & ASSOCIATES

- GEOTECHNICAL TESTING - SOIL BEARING CAPACITIES CONCRETE TESTING

COPIES OF ALL REPORTS TO BE SUBMITTED TO THE BUILDING DEPARTMENT OF MACOMB TOWNSHIP

Proposed New Apartments for:

M J C

Attic Areas & Ventilation Requirements

(PER MBC 2015 SEC 1203) ATTIC AREAS Above Unit B: 1,611 S.F.

Above Unit C: 1,726 S.F.

VENTILATION AREA REQUIRED: 1/300 ALLOWED (Per 1203.2) IF: MORE THAN 50% AND LESS THAN 80% OF REQUIRED VENTILATION TO BE LOCATED IN THE UPPER PORTION OF THE ATTIC SPACE Unit B: 1,611 S.F. $\times 1/300 = 5.37$ S.F. Unit C: 1,726 S.F. $\times 1/300 = 5.75$ S.F.

VENTILATION AREA PROVIDED: Unit B: 36'-0" L.F. Soffit Vent @ 5 Sq. In./Ft. = 180 Sq. In. 144 Sq. In. perl. 25. St. Ft. Unit B: (10) Style 600 Roof Vents @ 60 Sq. = 600 Sq. In.

144 Sq. In. per4.\$7 . \$7 . Ft. Unit B: Total Ventilation Area = 5.42 S.F. > 5.37 S.F. Required (77% OF VENTILATION IN UPPER PORTION OF ATTIC) Unit C: 80'-0" L.F. Soffit Vent @ 5 Sq. In./Ft. = 400 Sq. In. 144 Sq. In. per². Sq. Fq. Ft. Unit C: (11) Style 600 Roof Vents @ 60 Sq. = 660 Sq. In.

144 Sq. In.\bar{p}er^4.\bar{5}\bar{8}. \bar{9}q. Ft. Unit C: Total Ventilation Area = 7.36 S.F. > 5.75 S.F. Required (62% OF VENTILATION IN UPPER PORTION OF ATTIC)

1. ROOF VENT SPECS. PROVIDED ARE BY "LOMANCO VENTS" 2. PERFORATED SOFFIT/EAVE VENTS ARE JAMES HARDIE 3 . ALUM. ROOF VENTS ARE LOMANCO - 600 SERIES

Project Professionals:

Architects:

Burmann Associates Inc. 119 W. St. Clair Romeo, Michigan 48065 o.586-752-5010 c.586-201-1602 greatarchitects@charter.net Řichard E. Burmann R.A. Michigan #20749

Structural Engineering: Simpson Engineering L.L.C. 119 W. St. Clair Romeo, Michigan 48065 o.586-752-9872 c.810-614-5696 mpsimpson1959@yahoo.com Mark P. Simpson P.E. Michigan #33208

Mechanical Engineering: Beechwood Engineering, P.L.C. 3462 Beechwood Farmington Hills, Michigan 48335 248-408-8178 krj@sbcglobal.net Kenneth R. Jenkins P.E. Michigan #20003

Electrical Engineering: Current Design L.L.C. 1290 Brook Lane Rochester Hills, Michigan 48306 248-651-3681 currentdm@aol.com Dominic A. Moceri

SEPARATE SUBMITTAL:

CIVIL ENGINEERING DESIGN & DRAWINGS ARE DONE BY OTHERS AND ARE NOT PART OF THIS SUBMITTAL

FIRE SUPRESSION DESIGN & DRAWINGS ARE DONE BY OTHERS AND ARE NOT PART OF THIS SUBMITTAL

Sheet Index: Cover Page Foundation Plan First Floor Plan Second Floor Plan Elevations **Building Sections** Wall Sections Wall Sections & Details Wall Sections & Details Specifications Door Schedule 10


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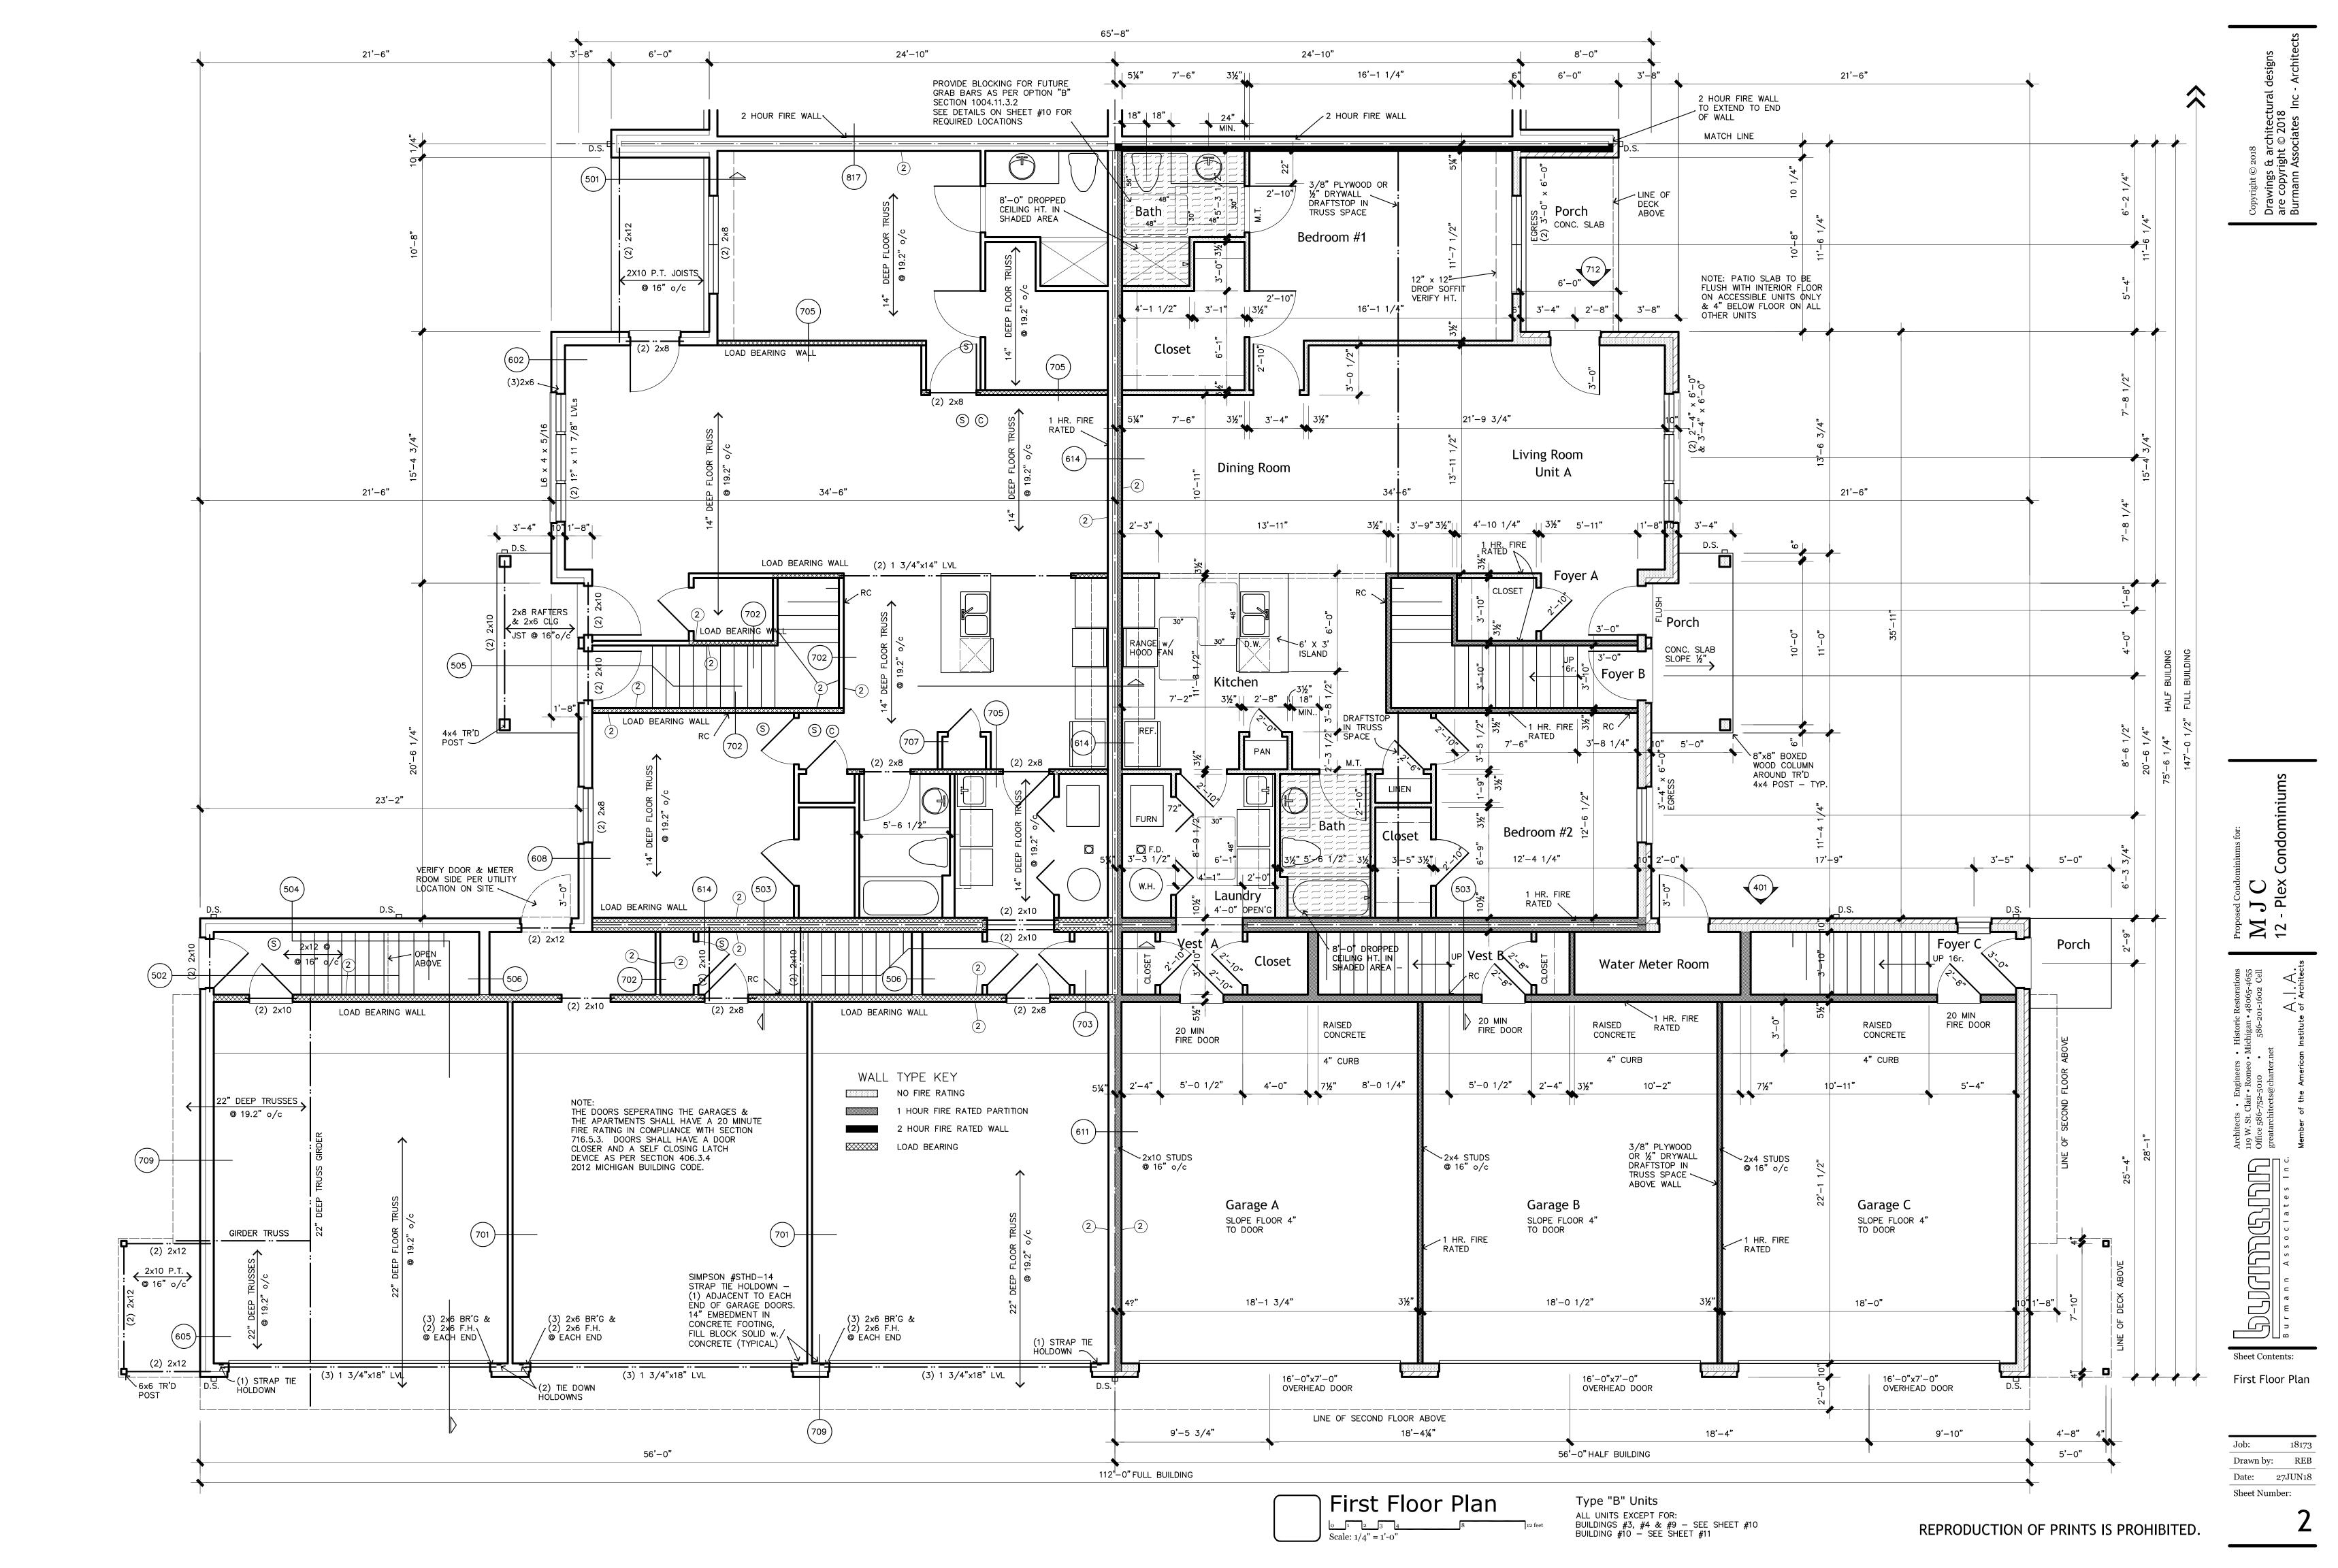
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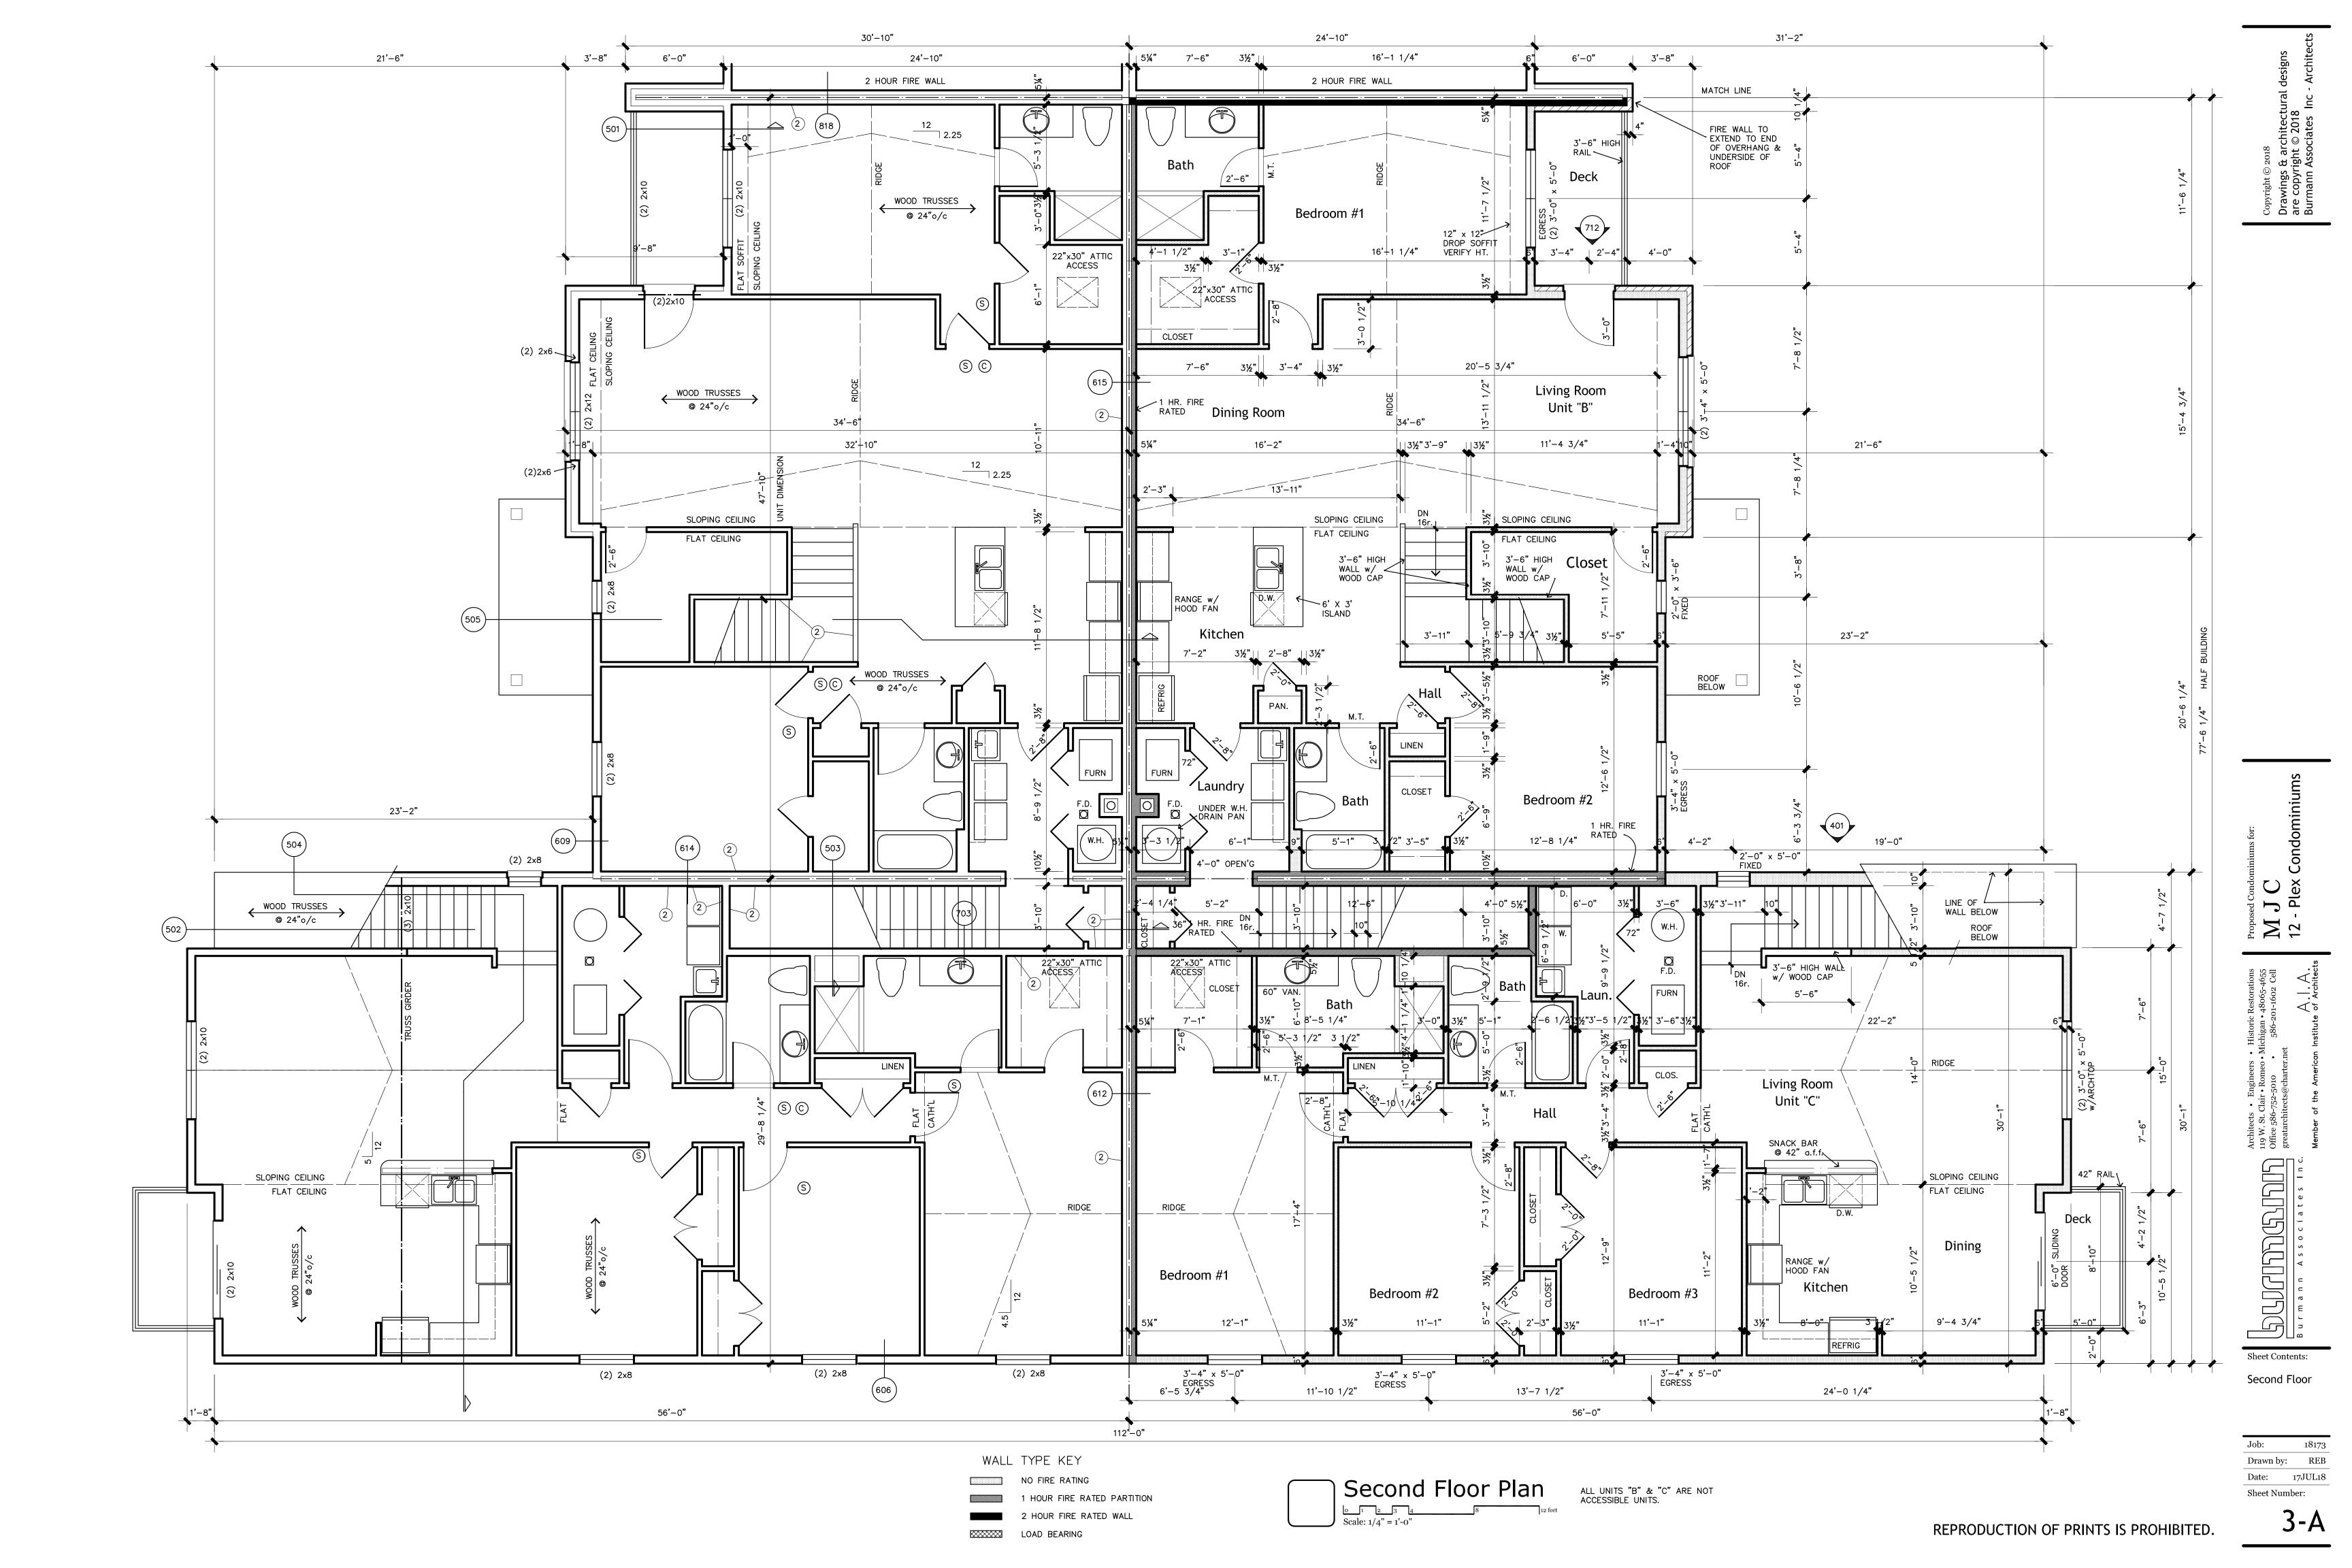




greatarchitects@charter.net





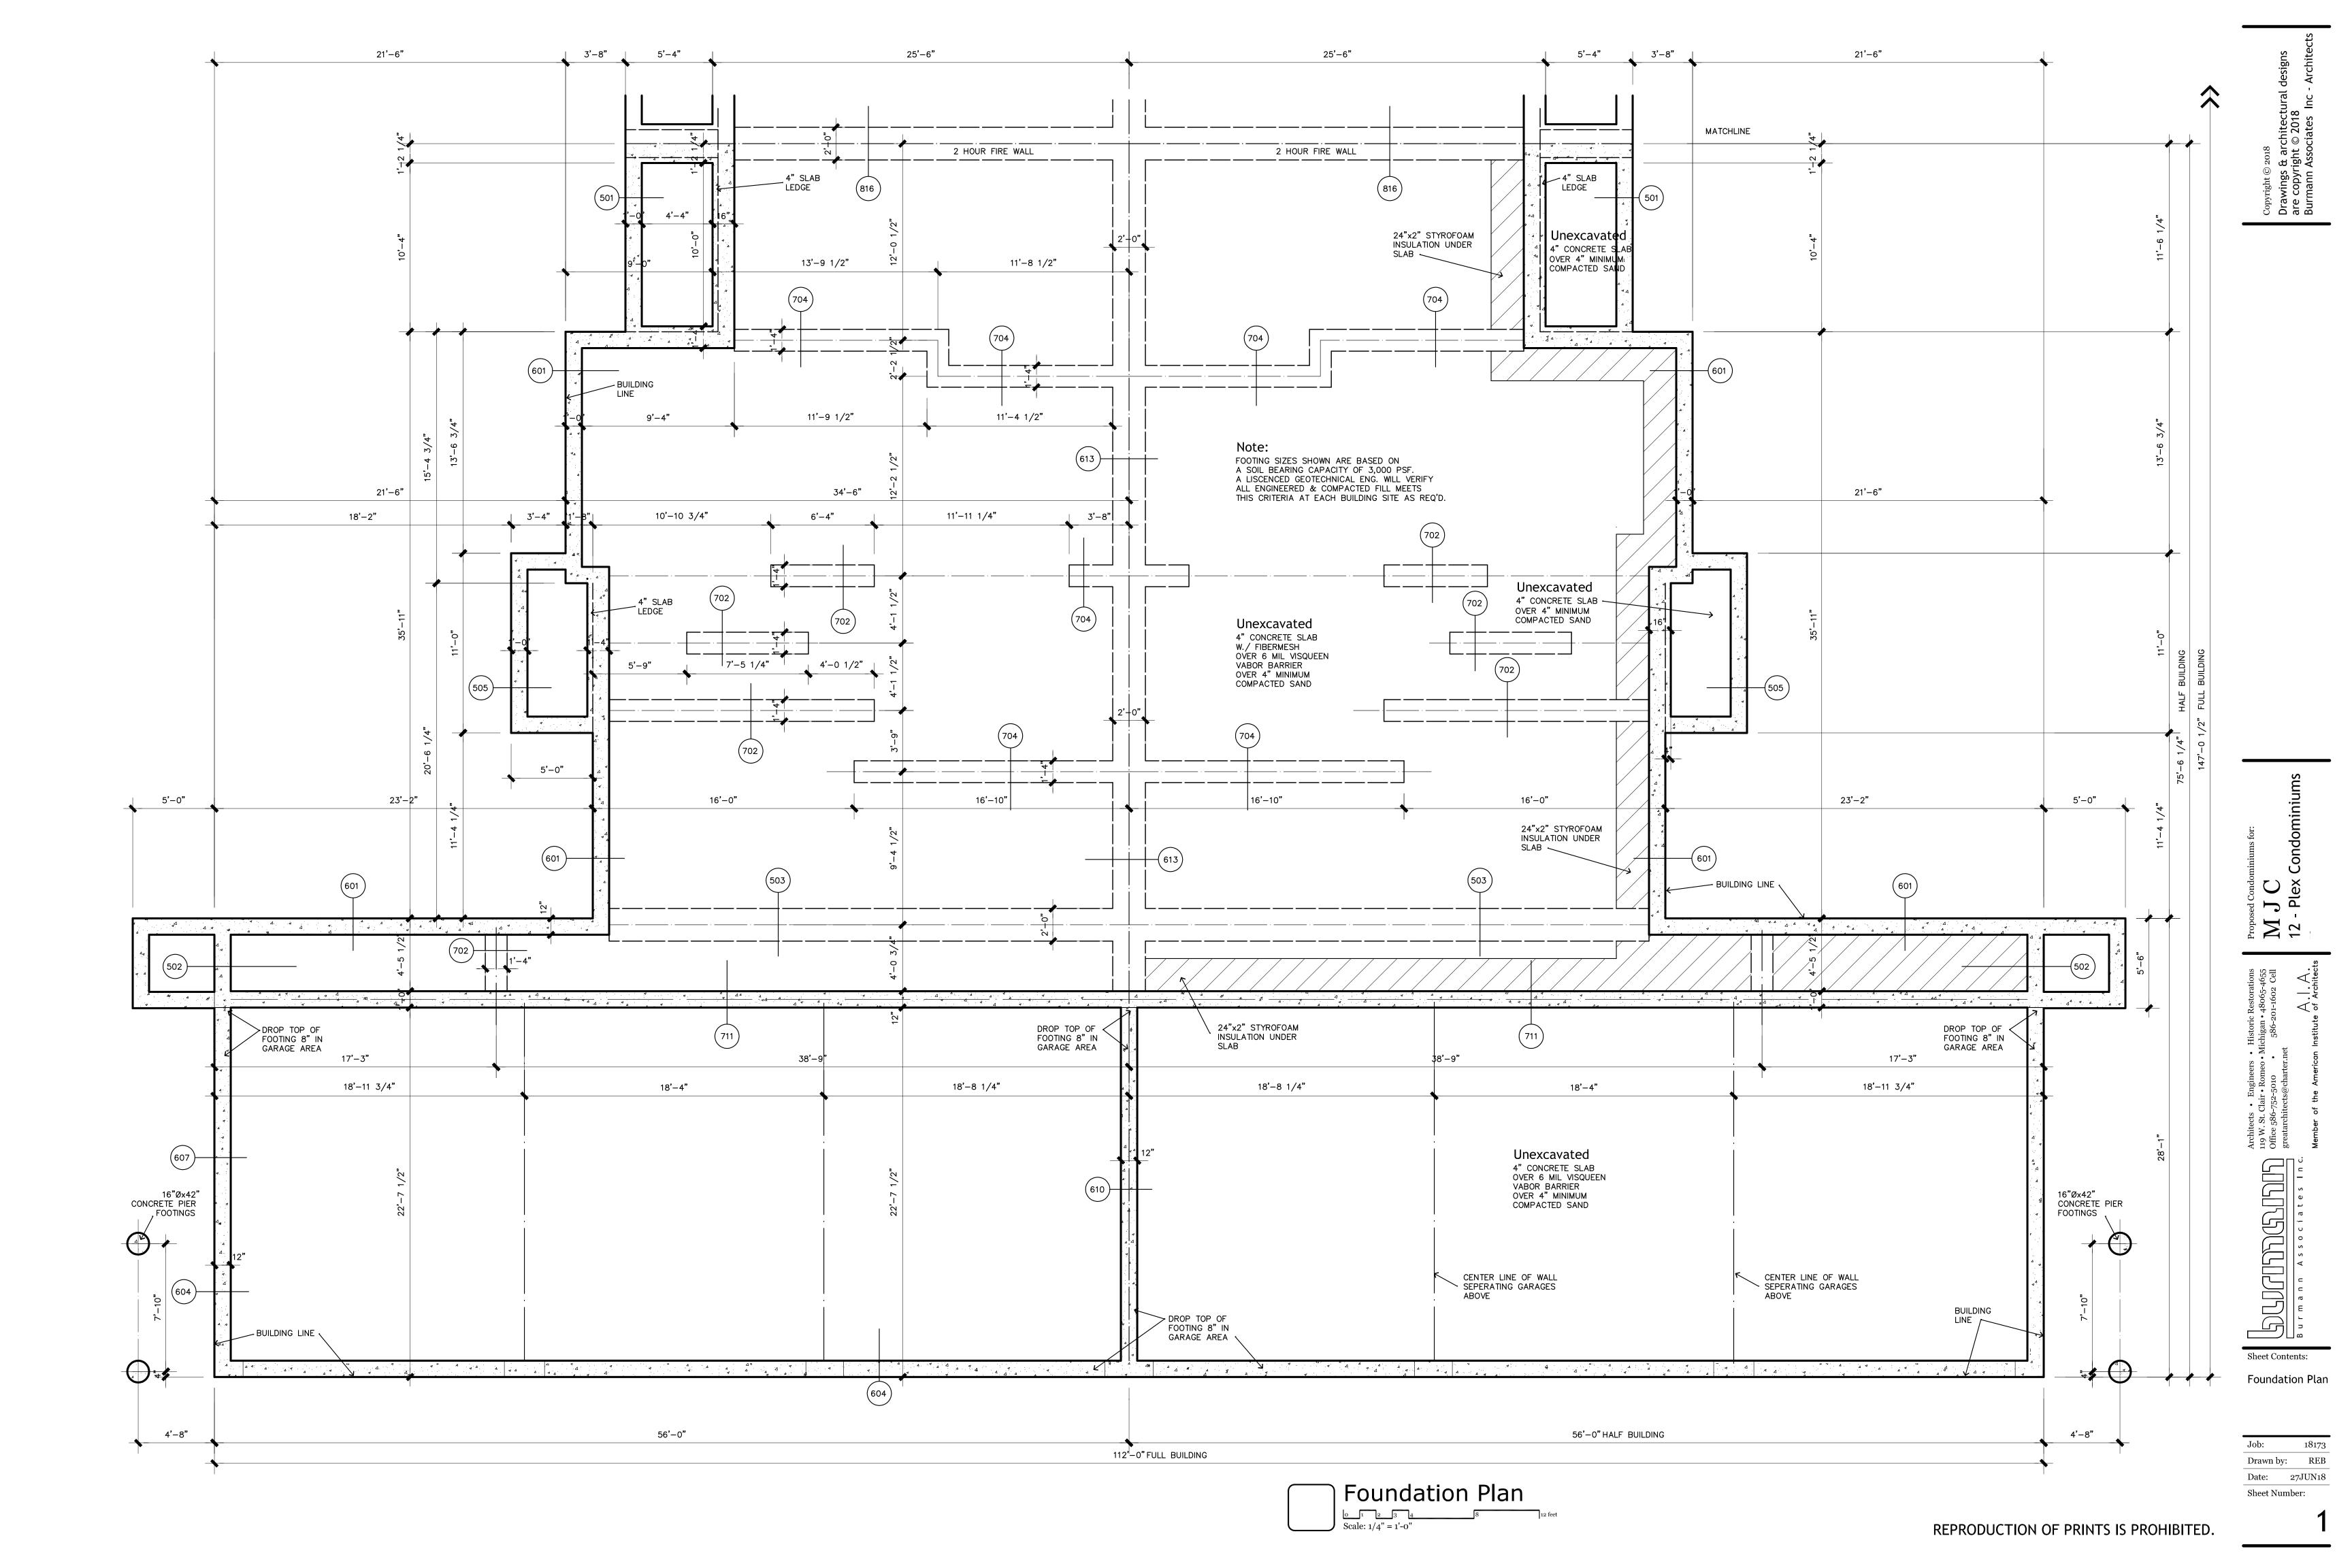



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